SHEET INDEX DESCRIPTION TITLE SHEET GENERAL NOTES OVERALL SITE PLAN COMPOUND SITE PLAN & ELEVATION EQUIPMENT SITE PLANS EQUIPMENT DETAILS ANTENNA PLANS DETAILS FIBER DISTRIBUTION BOX DETAILS Z8 DETAILS

DRIVING DIRECTIONS

DEPART FROM SPRINT: INTERNATIONAL BLVD MAHWAH, NJ 07430

- HEAD NORTHWEST ON INTERNATIONAL BLVD/PARK ST TOWARD QUEENSLAND RD. CONTINUE TO
- CONTINUE ONTO PARK ST. TURN RIGHT ONTO PARK LN.
- CONTINUE ONTO LEISURE EN MERGE ONTO NOTIT N.
- TAKE THE NEW JERSEY 17 N/INTERSTATE 287 N EXIT ON THE LEFT TOWARD INTERSTATE 87/NORTH
- KEEP LEFT AT THE FORK, FOLLOW SIGNS FOR 1-287 N/I-87/NJ-17 N/N Y. THRUWAY AND MERGE
- TAKE THE EXIT ON THE LEFT ONTO 1-87 N/NY-17 N TOWARD ALBANY
- CONTINUE TO FOLLOW (-87 N. KEEP LEFT AT THE FORK TO STAY ON 1-87 N.
- TAKE EXIT 17 FOR INTERSTATE 84/NEW YORK 300/NEW YORK 17K TOWARD SCRANTON/NEWBURGH.
- KEEP LEFT, FOLLOW SIGNS FOR INTERSTATE 84/NEW YORK 300/NEW YORK 17K. KEEP LEFT TO CONTINUE TOWARD NY-300 N/UNION AVE
- 10. KEEP RIGHT TO CONTINUE TOWARD NY-300 N/UNION AVE.
- KEEP LEFT AT THE FORK, FOLLOW SIGNS FOR INTERSTATE 84 W/STEWART AIRPORT/SCRANTON/NEW YORK 300/NEW YORK 17K/NEWBURGH.
- 12. KEEP RIGHT, FOLLOW SIGNS FOR NEW YORK 300/NEW YORK 17K/NEWBURGH.
- 13. CONTINUE ON NY-300 N. TAKE UNION AVE TO VALLEY VIEW DR.
- 14. TURN LEFT ONTO NY-300 N/UNION AVE. CONTINUE TO FOLLOW NY-300 N.

16. TURN LEFT ONTO VALLEY VIEW OR, DESTINATION WILL BE ON THE RIGHT.

15. TURN LEFT ONTO GARDNERTOWN RD. TAKE THE 1ST RIGHT ONTO UNION AVE.

Sprint

NETWORK VISION MMBTS & 2.5 EQUIPMENT LAUNCH **NEW YORK CENTRAL MARKET**

SPRINT SITE NAME

NEWBURGH CENTRAL

SPRINT SITE NUMBER

AL81XC305


CROWN CASTLE BU #

807196

SITE ADDRESS

VALLEY VIEW DR NEWBURGH, NY 12550

STRUCTURE TYPE SELF SUPPORT TOWER

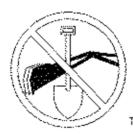

UNDERGROUND SERVICE ALERT **CALL TOLL FREE** 1-800-922-4455

PROJECT SUMMARY

NEWBURGH CENTRAL

SITE NAME:

AL81XC305 SITE NO.:

807196 CROWN CASTLE BU NO.:

VALLEY VIEW DR SITE ADDRESS: NEWBURGH, NY 12550

ORANGE COUNTY COUNTY:

SITE COORDINATES:

(NAD 83) LATITUDE: 41° 33′ 4.8″ N (NAD 83) 74° 5′ 1.1" W LONGITUDE: (AMSL) GROUND ELEV .: 15--1--10

<u>S/B/L:</u>

JURISDICTION: TOWN OF NEWBURGH

<u>ZONING:</u> R1-RESIDENTIAL

TELCO PROVIDER: VERIZON - (855) 277-5195

AT&T - (800) 288-2020 IBER PROVIDER:

LAND OWNER: CROWN ATLANTIC COMPANY LLC

120 VALLEY VIEW DR NEWBURGH NY 12550

SPRINT APPLICANT:

1 INTERNATIONAL BLVD. MAHWAH, NJ 07495

CONSTRUCTION MANAGER:

INFINIGY ENGINEER:

1033 WATERVLIET SHAKER RD

ALBANY, NY 12205

CONTACT: AJ DESANTIS - (518) 690-0790


NY BUILDING CODE BUILDING CODE:

UNIFORM BUILDING CODE BUILDING OFFICIALS & CODE ADMINISTRATORS

UNIFORM MECHANICAL CODE UNIFORM PLUMBING CODE LOCAL BUILDING CODE CITY/COUNTY ORDINANCES


THREE WORKING DAYS BEFORE YOU DID ELECTRICAL CODE: NATIONAL ELECTRICAL CODE (LATEST EDITION)

VICINITY MAP

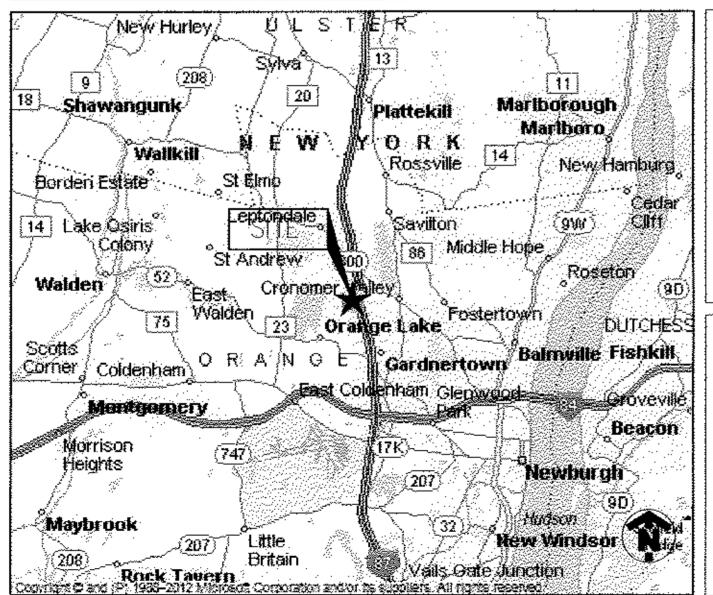

PROJECT TEAM

CANONSBURG, PA 15317

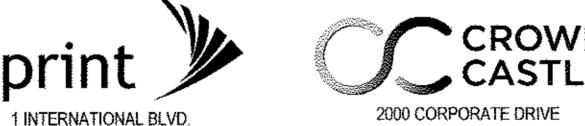

INFINIGY®

1033 Watervliet Shaker Rd Albany, NY 12205 OFFICE #: (518) 690-0790 FAX #: (518) 690-0793

ENGINEER

CUSTOMER

SCOPE OF WORK:

- HANDICAP ACCESS REQUIREMENTS ARE NOT REQUIRED
- FACILITY IS UNMANNED AND NOT FOR HUMAN HABITATION.
- FACILITY HAS NO PLUMBING OR REFRIGERANTS

MAHWAH, NJ 07495

- THIS FACILITY SHALL MEET OR EXCEED ALL FAA AND FCC REGULATORY REQUIREMENTS
- ALL NEW MATERIAL SHALL BE FURNISHED AND INSTALLED BY CONTRACTOR UNLESS NOTED OTHERWISE, CABINETS, ANTENNAS/RRU AND CABLES FURNISHED BY OWNER AND INSTALLED BY CONTRACTOR

- INSTALL (9) NEW ANTENNAS & RRH'S ON EXISTING TOWER
- INSTALL NEW N.V. BTS CABINET TO REPLACE EXISTING
- REMOVE EXISTING CDMA ANTENNAS AND COAX CABLES
- INSTALL NEW BATTERY TO REPLACE EXISTING CABINET.
- REPLACE EXISTING GPS IF REQUIRED

INSTALL'(27) JUMPER CABLES

INSTALL (1) FIBER CABLE & (3) HYBRIFLEX CABLES

ENGINEER'S LICENSE

CERTIFICATION STATEMENT

HEREBY CERTIFY THAT THESE DOCUMENTS WERE PREPARED OR APPROVED BY ME, AND THAT I AM A DULY LICENSED PROFESSIONAL ENGINEER UNDER THE LAWS OF THE STATE OF NEW YORK.

LICENSED ENGINEER - STATE OF NEW YORK

APPROVALS

	711110 V/LO		
SPRINT MANAGER		DATE	
SPRINT RF	,	DATE	
LEASING/SITE ACQ.		DATE	
IN-MARKET CONSTRUCTION LEAD		DATE	
SITE OWNER	NAME/COMPANY: TITLE:	DATE	



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NEWBURGH CENTRAL AL81XC305

VALLEY VIEW DR NEWBURGH, NY 12550

print

Prepared For

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Drawing Scale: AS NOTED

4/28/15

Drawing Title

TITLE SHEET

Drawing Number

T1

GENERAL NOTES

PART 1 - GENERAL REQUIREMENTS

- 1.1 THE WORK SHALL COMPLY WITH APPLICABLE NATIONAL CODES AND STANDARDS, LATEST EDITION, AND PORTIONS THEREOF, INCLUDED BUT NOT LIMITED TO THE FOLLOWING:
 - A. GR-63-CORE NEBS REQUIREMENTS: PHYSICAL PROTECTION

 D. OD 78 CODE CENERIC REQUIREMENTS FOR THE PHYSICAL DESI
 - 8. GR-78-CORE GENERIC REQUIREMENTS FOR THE PHYSICAL DESIGN AND MANUFACTURE OF TELECOMMUNICATIONS EQUIPMENT.
 - C. NATIONAL FIRE PROTECTION ASSOCIATION CODES AND STANDARDS (NEPA) INCLUDING NEPA 70 (NATIONAL ELECTRICAL CODE — "NEC").
 D. AND NEPA 101 (LIFE SAFETY CODE).
 - E. AMERICAN SOCIETY FOR TESTING OF MATERIALS (ASTM).
 - F. INSTITUTE OF ELECTRONIC AND ELECTRICAL ENGINEERS (IEEE).

1.2 DEFINITIONS:

- A: WORK: THE SUM OF TASKS AND RESPONSIBILITIES IDENTIFIED IN THE CONTRACT DOCUMENTS.
- B: COMPANY: SPRINT NEXTEL CORPORATION

 C. ENGINEER: SYNONYMOUS WITH ARCHITECT & ENGINEER AND "A&E".

 THE DESIGN PROFESSIONAL HAVING PROFESSIONAL RESPONSIBILITY FOR
- DESIGN OF THE PROJECT.

 D: CONTRACTOR: CONSTRUCTION CONTRACTOR; CONSTRUCTION VENDOR; INDIVIDUAL OR ENTITY WHO AFTER EXECUTION OF A CONTRACT IS BOUND TO ACCOMPLISH THE WORK.
- E: THERD PARTY VENDOR OR AGENCY: A VENDOR OR AGENCY ENGAGED SEPARATELY BY THE COMPANY, A&E, OR CONTRACTOR TO PROVIDE MATERIALS OR TO ACCOMPLISH SPECIFIC TASKS RELATED TO BUT NOT INCLUDED IN THE WORK.
- 1.3 POINT OF CONTACT: COMMUNICATION BETWEEN THE COMPANY AND THE CONTRACTOR SHALL FLOW THROUGH THE SINGLE COMPANY SITE DEVELOPMENT SPECIALIST OR OTHER PROJECT COORDINATOR APPOINTED TO MANAGE THE PROJECT FOR THE COMPANY.
- 1.4 ON-SITE SUPERVISION: THE CONTRACTOR SHALL SUPERVISE AND DIRECT THE WORK AND SHALL BE RESPONSIBLE FOR CONSTRUCTION MEANS, METHODS, TECHNIQUES, SEQUENCES, AND PROCEDURES IN ACCORDANCE WITH THE CONTRACT DOCUMENTS. THE CONTRACTOR SHALL EMPLOY A COMPETENT SUPERINTENDENT WHO SHALL BE IN ATTENDANCE AT THE SITE AT ALL TIMES DURING PERFORMANCE OF THE WORK.
- 1.5 DRAWINGS, SPECIFICATIONS AND DETAILS REQUIRED AT JOBSITE: THE CONSTRUCTION CONTRACTOR SHALL MAINTAIN A FULL SET OF THE CONSTRUCTION DRAWINGS, STANDARD CONSTRUCTION DETAILS FOR WIRELESS SITES, AND THE STANDARD CONSTRUCTION SPECIFICATIONS FOR WIRELESS SITES AT THE JOBSITE FROM MOBILIZATION THROUGH CONSTRUCTION COMPLETION.

 A. THE JOBSITE DRAWINGS, SPECIFICATIONS AND DETAILS SHALL BE CLEARLY MARKED DAILY IN PENCIL WITH ANY CHANGES IN CONSTRUCTION OVER WHAT IS DEPICTED IN THE DOCUMENTS. AT CONSTRUCTION COMPLETION, THIS JOBSITE MARKUP SET SHALL BE DELIVERED TO THE COMPANY OR COMPANY'S DESIGNATED REPRESENTATIVE TO BE
- 1.6 USE OF JOB SITE: THE CONTRACTOR SHALL CONFINE ALL CONSTRUCTION AND RELATED OPERATIONS INCLUDING STAGING AND STORAGE OF MATERIALS AND EQUIPMENT, PARKING, TEMPORARY FACILITIES, AND WASTE STORAGE TO THE LEASE PARCEL UNLESS OTHERWISE PERMITTED BY THE

FORWARDED TO THE COMPANY'S A&E VENDOR FOR PRODUCTION OF

1.7 NOTICE TO PROCEED:

A. NO WORK SHALL COMMENCE PRIOR TO COMPANY'S WRITTEN NOTICE TO PROCEED.

8. UPON RECEIVING NOTICE TO PROCEED, CONTRACTOR SHALL FULLY PERFORM ALL WORK NECESSARY TO PROVIDE SPRINT NEXTEL WITH AN OPERATIONAL WIRELESS FACILITY.

PART 2 - EXECUTION

"AS-BUILT" DRAWINGS.

CONTRACT DOCUMENTS.

- TEMPORARY UTILITIES AND FACILITIES: THE CONTRACTOR SHALL BE RESPONSIBLE FOR ALL TEMPORARY UTILITIES AND FACILITIES NECESSARY EXCEPT AS OTHERWISE INDICATED IN THE CONSTRUCTION DOCUMENTS. TEMPORARY UTILITIES AND FACILITIES INCLUDE, POTABLE WATER, HEAT, HVAC, ELECTRICITY, SANITARY FACILITIES, WASTE DISPOSAL FACILITIES, AND TELEPHONE/COMMUNICATION SERVICES. PROVIDE TEMPORARY UTILITIES AND FACILITIES IN ACCORDANCE WITH OSHA AND THE AUTHORITY HAVING JURISDICTION. CONTRACTOR MAY UTILIZE THE COMPANY ELECTRICAL SERVICE IN THE COMPLETION OF THE WORK WHEN IT BECOMES AVAILABLE. USE OF THE LESSORS OR SITE OWNER'S UTILITIES OR FACILITIES IS EXPRESSLY FORBIDDEN EXCEPT AS OTHERWISE ALLOWED IN THE CONTRACT DOCUMENTS.
- 2.2 ACCESS TO WORK: THE CONTRACTOR SHALL PROVIDE ACCESS TO THE JOB SITE FOR AUTHORIZED COMPANY PERSONNEL AND AUTHORIZED REPRESENTATIVES OF THE ARCHITECT/ENGINEER DURING ALL PHASES OF THE WORK.
- 2.3 TESTING: REQUIREMENTS FOR TESTING BY THIS CONTRACTOR SHALL BE AS INDICATED HEREWITH, ON THE CONSTRUCTION DRAWINGS, AND IN THE INDIVIDUAL SECTIONS OF THESE SPECIFICATIONS. SHOULD COMPANY CHOOSE TO ENGAGE ANY THIRD—PARTY TO CONDUCT ADDITIONAL TESTING, THE CONTRACTOR SHALL COOPERATE WITH AND PROVIDE A WORK AREA FOR COMPANY'S TEST AGENCY.

2.4 COMPANY FURNISHED MATERIAL AND EQUIPMENT: ALL HANDLING, STORAGE | 6.1 AND RINSTALLATION OF COMPANY FURNISHED MATERIAL AND EQUIPMENT SHALL BE IN ACCORDANCE WITH THE REQUIREMENTS OF THE CONTRACT DOCUMENTS AND WITH THE MANUFACTURER'S INSTRUCTIONS AND RECOMMENDATIONS.

- AL CONTRACTOR SHALL PROCURE ALL OTHER REQUIRED WORK RELATED MATERIALS NOT PROVIDED BY SPRINT NEXTEL TO SUCCESSFULLY CONSTRUCT A WIRELESS FACILITY.
- 2.5 DIMENSIONS: VERIFY DIMENSIONS INDICATED ON DRAWINGS WITH FIELD DIMENSIONS BEFORE FABRICATION OR ORDERING OF MATERIALS, DO NOT SCALE DRAWINGS.
- 2.6 EXISTING CONDITIONS: NOTIFY THE COMPANY REPRESENTATIVE OF EXISTING CONDITIONS DEFERING FROM THOSE INDICATED ON THE DRAWINGS. DO NOT REMOVE OR ALTER STRUCTURAL COMPONENTS WITHOUT PRIOR WRITTEN APPROVAL FROM THE ARCHITECT AND ENGINEER.

PART 3 - RECEIPT OF MATERIAL & EQUIPMENT

- 1 RECEIPT OF MATERIAL AND EQUIPMENT: CONTRACTOR IS RESPONSIBLE FOR SPRINT NEXTEL PROVIDED MATERIAL AND EQUIPMENT AND UPON RECEIPT SHALL:

 A. ACCEPT DELIVERIES AS SHIPPED AND TAKE RECEIPT.
- B. VERBY COMPLETENESS AND CONDITION OF ALL DELIVERIES.
 C. TAKE RESPONSIBILITY FOR EQUIPMENT AND PROVIDE INSURANCE PROTECTION AS REQUIRED IN AGREEMENT.
 D. RECORD ANY DEFECTS OR DAMAGES AND WITHIN TWENTY—FOUR HOURS AFTER RECEIPT, REPORT TO SPRINT NEXTEL OR ITS DESIGNATED
- E. PROVIDE SECURE AND NECESSARY WEATHER PROTECTED WAREHOUSING. F. COORDINATE SAFE AND SECURE TRANSPORTATION OF MATERIAL AND EQUIPMENT, DELIVERING AND OFF-LOADING FROM CONTRACTOR'S WAREHOUSE TO SITE.

PART 4 - GENERAL REQUIREMENTS FOR CONSTRUCTION

- 4.1 CONTRACTOR SHALL KEEP THE SITE FREE FROM ACCUMULATING WASTE MATERIAL, DEBRIS, AND TRASHL AT THE COMPLETION OF THE WORK, CONTRACTOR SHALL REMOVE FROM THE SITE ALL REMAINING RUBBISH, IMPLEMENTS, TEMPORARY FACILITIES, AND SURPLUS MATERIALS.
- 4.2 EQUIPMENT ROOMS SHAEL AT ALL TIMES BE MAINTAINED "BROOM CLEAN" AND CLEAR OF DEBRIS.
- 4.3 CONTRACTOR SHALL TAKE ALL REASONABLE PRECAUTIONS TO DISCOVER AND LOCATE ANY HAZARDOUS CONDITION.

 A. IN THE EVENT CONTRACTOR ENCOUNTERS ANY HAZARDOUS CONDITION WHICH HAS NOT BEEN. ABATED OR OTHERWISE MITIGATED, CONTRACTOR AND ALL OTHER PERSONS SHALL IMMEDIATELY STOP WORK IN THE AFFECTED AREA. AND NOTIFY COMPANY IN WRITING, THE WORK IN THE
 - 8Y COMPANY.

 8. CONTRACTOR AGREES TO USE CARE WHILE ON THE SITE AND SHALL NOT TAKE ANY ACTION THAT WILL OR MAY RESULT IN OR CAUSE THE HAZARDOUS CONDITION TO BE FURTHER RELEASED IN THE ENVIRONMENT, OR TO FURTHER EXPOSE INDIVIDUALS TO THE HAZARD.

AFFECTED AREA SHALL NOT BE RESUMED EXCEPT BY WRITTEN NOTIFICATION

- 4.4 CONTRACTOR'S ACTIVITIES SHALL BE RESTRICTED TO THE PROJECT LIMITS.
 SHOULD AREAS OUTSIDE THE PROJECT LIMITS BE AFFECTED BY
 CONTRACTOR'S ACTIVITIES, CONTRACTOR SHALL IMMEDIATELY RETURN THEM
 TO ORIGINAL CONDITION.
- 4.5 CONDUCT TESTING AS REQUIRED HEREIN

PROJECT REPRESENTATIVE OF SUCH.

PART 5 — TESTS AND INSPECTIONS

- 5.1 TESTS AND INSPECTIONS:

 A. THE CONTRACTOR SHALL BE RESPONSIBLE FOR ALL CONSTRUCTION
 TESTS, INSPECTIONS AND PROJECT DOCUMENTATION.
 - B. CONTRACTOR SHALL COORDINATE TEST AND INSPECTION SCHEDULES WITH COMPANY'S REPRESENTATIVE WHO MUST BE ON SITE TO WITNESS SUCH TESTS AND INSPECTIONS.
 - C. WHEN THE USE OF A THIRD PARTY INDEPENDENT TESTING AGENCY IS REQUIRED, THE AGENCY THAT IS SELECTED MUST PERFORM SUCH WORK ON A REGULAR BASIS IN THE STATE WHERE THE PROJECT IS LOCATED AND HAVE A THOROUGH UNDERSTANDING OF LOCAL AVAILABLE MATERIALS, INCLUDING THE SOIL, ROCK, AND GROUNDWATER CONDITIONS.
 - D. THE THIRD PARTY TESTING AGENCY IS TO BE FAMILIAR WITH THE APPLICABLE REQUIREMENTS FOR THE TESTS TO BE DONE, EQUIPMENT TO BE USED, AND ASSOCIATED HEALTH AND SAFETY ISSUES.

 E. SITE RESISTANCE TO EARTH TESTING PER EXHIBIT: CELL SITE GROUNDING SYSTEM DESIGN.
 - F. ANTENNA AND COAX SWEEP TESTS PER EXHIBIT: ANTENNA TRANSMISSION LINE ACCEPTANCE STANDARDS. HYBRIFLEX TESTING NOT LIMITED TO COAX SWEEPS.
 - G. ALL OTHER TESTS REQUIRED BY COMPANY OR JURISDICTION.

PART 6 - TRENCHING AND BACKFILLING

- 6.1 TRENCHING AND BACKFILLING: THE CONTRACTOR SHALL PERFORM ALL EXCAVATION OF EVERY DESCRIPTION AND OF WHATEVER SUBSTANCES ENCOUNTERED, TO THE DEPTHS INDICATED ON THE CONSTRUCTION DRAWINGS OR AS OTHERWISE SPECIFIED.
 - A. PROTECTION OF EXISTING UTILITIES: THE CONTRACTOR SHALL CHECK WITH THE LOCAL UTILITIES AND THE RESPECTIVE UTILITY LOCATOR COMPANIES PRIOR TO STARTING EXCAVATION OPERATIONS IN EACH RESPECTIVE AREA TO ASCERTAIN THE LOCATIONS OF KNOWN UTILITY LINES. THE LOCATIONS, NUMBER AND TYPES OF EXISTING UTILITY LINES DETAILED ON THE CONSTRUCTION DRAWINGS ARE APPROXIMATE AND DO NOT REPRESENT EXACT INFORMATION. THE CONTRACTOR SHALL BE RESPONSIBLE FOR REPAIRING ALL LINES DAMAGED DURING EXCAVATION AND ALL ASSOCIATED OPERATIONS. ALL UTILITY LINES UNCOVERED DURING THE EXCAVATION OPERATIONS, SHALL BE PROTECTED FROM DAMAGE DURING EXCAVATION AND ASSOCIATED OPERATIONS. ALL REPAIRS SHALL BE APPROVED BY THE UTILITY COMPANY.
 - B. HAND DIGGING: UNLESS APPROVED IN WRITING OTHERWISE, ALL DIGGING WITHIN AN EXISTING CELL SITE COMPOUND IS TO BE DONE BY HAND.
 - C. DURING EXCAVATION, MATERIAL SUITABLE FOR BACKFILLING SHALL BE STOCKPILED IN AN ORDERLY MANNER A SUFFICIENT DISTANCE FROM THE BANKS OF THE TRENCH TO AVOID OVERLOADING AND TO PREVENT SLIDES OR CAVE—INS. ALL EXCAVATED MATERIALS NOT REQUIRED OR SUITABLE FOR BACKFILL SHALL BE REMOVED AND DISPOSED OF AT THE CONTRACTOR'S EXPENSE.
 - D. GRADING SHALL BE DONE AS MAY BE NECESSARY TO PREVENT SURFACE WATER FROM FLOWING INTO TRENCHES OR OTHER EXCAVATIONS, AND ANY WATER ACCUMULATING THEREIN SHALL BE REMOVED BY PUMPING OR BY OTHER APPROVED METHOD.
 - E. SHEETING AND SHORING SHALL BE DONE AS NECESSARY FOR THE PROTECTION OF THE WORK AND FOR THE SAFETY OF PERSONNEL UNLESS OTHERWISE INDICATED, EXCAVATION SHALL BE BY OPEN CUT, EXCEPT THAT SHORT SECTIONS OF A TRENCH MAY BE TUNNELED IF, THE CONDUIT CAN BE SAFELY AND PROPERLY INSTALLED AND BACKFILL CAN BE PROPERLY TAMPED IN SUCH TUNNEL SECTIONS. EARTH EXCAVATION SHALL COMPRISE ALL MATERIALS AND SHALL INCLUDE CLAY, SILT, SAND, MUCK, GRAVEL, HARDPAN, LOOSE SHALE, AND LOOSE STONE.
 - F. TRENCHES SHALL BE OF NECESSARY WOTH FOR THE PROPER LAYING OF THE CONDUIT OR CABLE, AND THE BANKS SHALL BE AS NEARLY VERTICAL AS PRACTICABLE. THE BOTTOM OF THE TRENCHES SHALL BE ACCURATELY GRADED TO PROVIDE HIMFORM BEARING AND SUPPORT FOR EACH SECTION OF THE CONDUIT OR CABLE ON UNDISTURBED SOIL AT EVERY POINT ALONG ITS ENTIRE LENGTH, EXCEPT WHERE ROCK IS ENCOUNTERED, CARE SHALL BE TAKEN NOT TO EXCAVATE BELOW THE DEPTHS INDICATED, WHERE ROCK EXCAVATIONS ARE NECESSARY, THE ROCK SHALL BE EXCAVATED TO A MINIMUM OVER DEPTH OF 6 INCHES BELOW THE TRENCH DEPTHS INDICATED ON THE CONSTRUCTION DRAWINGS OR SPECIFIED, OVER DEPTHS IN THE ROCK EXCAVATION AND UNAUTHORIZED OVER DEPTHS SHALL BE THOROUGHLY BACK FILLED AND TAMPED TO THE APPROPRIATE. GRADE, WHENEVER WET OR OTHERWISE UNSTABLE SOIL THAT IS INCAPABLE OF PROPERLY SUPPORTING THE CONDUIT OR CABLE IS ENCOUNTERED IN THE BOTTOM OF THE TRENCH, SUCH SOLID SHALL BE REMOVED TO A MINIMUM OVER DEPTH OF 6 INCHES AND THE TRENCH BACKFILLED TO THE PROPER GRADE WITH EARTH OF OTHER SUITABLE MATERIAL, AS HEREINAFTER SPECIFIED.
 - G. BACKFILLING OF TRENCHES, TRENCHES SHALL NOT BE BACKFILLED. UNTIL ALL SPECIFIED TESTS HAVE BEEN PERFORMED AND ACCEPTED, WHERE COMPACTED BACKFILL IS NOT INDICATED THE TRENCHES SHALL BE CAREFULLY BACKFILLED WITH SELECT MATERIAL SUCH AS EXCAVATED SOILS THAT ARE FREE OF ICE. SNOW, ROOTS, SOD, RUBBISH OR STONES, DEPOSITED IN 6 INCH. LAYERS AND THOROUGHLY AND CAREFULLY RAMMED UNTIL THE CONDUIT OR CABLE HAS A COVER OF NOT LESS THAN 1 FOOT. THE REMAINDER OF THE BACKFILL MATERIAL SHALL BE GRANULAR IN NATURE AND SHALL NOT CONTAIN ICE, SNOW ROOTS, SOD, RUBBISH, OR STONES OF 2-1/2 INCH MAXIMUM DIMENSION. BACKFILL SHALL BE CAREFULLY PLACED IN THE TRENCH AND IN 1 FOOT LAYERS AND EACH LAYER TAMPED, SETTLING THE BACKFILL WITH WATER WILL BE PERMITTED. THE SURFACE SHALL BE GRADED TO A REASONABLE UNIFORMITY AND THE MOUNDING OVER THE TRENCHES LEFT IN A UNIFORM AND NEAT CONDITION.

PROJECT INFORMATION

THIS IS AN UNMANNED AND RESTRICTED ACCESS EQUIPMENT FACILITY AND WILL BE USED FOR THE TRANSMISSION OF RADIO SIGNALS FOR THE PURPOSE OF PROVIDING PUBLIC WIRELESS COMMUNICATIONS SERVICE.

NO POTABLE WATER SUPPLY IS TO BE PROVIDED AT THIS LOCATION.

NO WASTE WATER WILL BE GENERATED AT THIS LOCATION.

NO SOLID WASTE WILL BE GENERATED AT THIS LOCATION.

SPRINT MAINTENANCE CREW (TYPICALLY ONE PERSON) WILL MAKE AN AVERAGE OF ONE TRIP PER MONTH AT ONE HOUR PER VISIT.

LEGEND

SYMBOL	DESCRIPTION
\triangle	CIRCUIT BREAKER
ބJ	NON-FUSIBLE DISCONNECT SWITCH
ŒĽ	FUSIBLE DISCONNECT SWITCH
	SURFACE MOUNTED PANEL BOARD
<u>[T]</u>	TRANSFORMER
·····	KILOWATT HOUR METER
JB]	JUNCTION BOX
PB	PULL BOX TO NEC/TELCO STANDARDS
	UNDERGROUND UTILITIES
(#)	DENOTES REFERENCE NOTE
	EXOTHERMIC WELD CONNECTION .
•	MECHANICAL CONNECTION
4 → OR ⊗	GROUND ROD
u⊱-⊕ OR 🔯	GROUND ROD WITH INSPECTION SLEEVE
-3	GROUND BAR
≪	PIN AND SLEEVE RECEPTACLE
\Leftrightarrow	120AC DUPLEX RECEPTACLE
(GROUND CONDUCTOR
(EPRESENTS DETAIL NUMBER EF. DRAWING NUMBER

ABBREVIATIONS

CIGBE MIGB SST GPS	COAX ISOLATED GROUND BAR EXTERNAL MASTER ISOLATED GROUND BAR SELF SUPPORTING TOWER GLOBAL POSITIONING SYSTEM
TYP.	TYPICAL
DWG	DRAWING
BCW	BARE COPPER WIRE
BFG	BELOW FINISH GRADE
PVC	POLYVINYL CHLORIDE
CAB	CABINET
C	CONDUIT
SS	STAINLESS STEEL
G	GROUND
AWG	AMERICAN WIRE GAUGE
RGS	RIGID GALVANIZED STEEL
AHJ	AUTHORITY HAVING JURISDICTION
TTLNA	TOWER TOP LOW NOISE AMPLIFIER
UNO	UNLESS NOTED OTHERWISE
EMT	ELECTRICAL METALLIC TUBING
AGL.	ABOVE GROUND LEVEL

FINANCE REPORT REPORT OF A SHARW NY 12205

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 4/28/55

 Checked:
 AD
 Date:
 4/28/15

Project Number 353-000

Project Title

NEWBURGH CENTRAL AL81XC305

VALLEY VIEW DR NEWBURGH, NY 12550

Prepared Fo


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Drawing Scale:
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Date:

4/28/15 Drawing Title

> GENERAL NOTES

Drawing Number

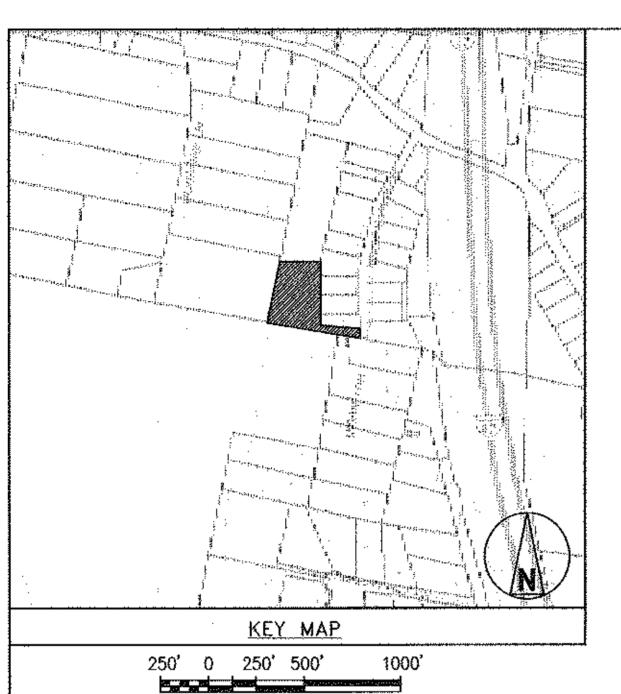

(IN FEET) SCALE: 24"x36" SHEET 1" = 500'-0" SCALE: 11"x17" SHEET 1" = 1000'-0"

LANDS N/F:

37 ROSALINE LANE

NEWBURGH NY 12550 S/B/L: 111-2-18

TABLE OF USE AND BULK REQUIREMENTS REQUIRED EXISTING PROPOSED ±100,188 NO CHANGE LOT AREA (SQFT.) SQFT LOT WIDTH (FT.) NO CHANGE NO CHANGE N/A ±460° LOT DEPTH (FT.) ±28' NO CHANGE FRONT YARD (FT.) ±117' NO CHANGE REAR YARD (FT.) NO CHANGE 士41' 1 SIDE YARD (FT.) ±301° NO CHANGE BOTH SIDE YARDS (FT.) ±0.525% 20% NO CHANGE LOT BUILDING COVERAGE (%) NO CHANGE BUILDING HEIGHT (FT)

±0.91%

NO CHANGE

NO PROPOSED TREE CLEARING CLEARING IS REQUIRED.

LOT SURFACE COVERAGE (%)

NO GRADING IS REQUIRED. NO EXCAVATION IS REQUIRED.

NO MATERIAL (FILL) WILL BE REQUIRED TO BRING THE SITE TO READINESS.

THERE ARE NO FLOOD PLAINS LOCATED ON OR NEAR THE SUBJECT PARCEL.

THERE ARE NO WETLANDS LOCATED ON OR NEAR THE SUBJECT PARCEL.

INFORMATION CONTAINED WITHIN DRAWINGS ARE BASED ON PROVIDED INFORMATION, ORANGE COUNTY NY GIS MAPPING & AERIAL PHOTOGRAPHY AND ARE NOT THE RESULT OF A FIELD SURVEY.





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Designed: A30 Date: 4/28/15 Checked: AJD Date: 4/28/15

Project Number

Project Title

NEWBURGH CENTRAL AL81XC305

VALLEY VIEW DR NEWBURGH, NY 12550




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4/28/15 Drawing Title

OVERALL SITE PLAN

60' Drawing Number



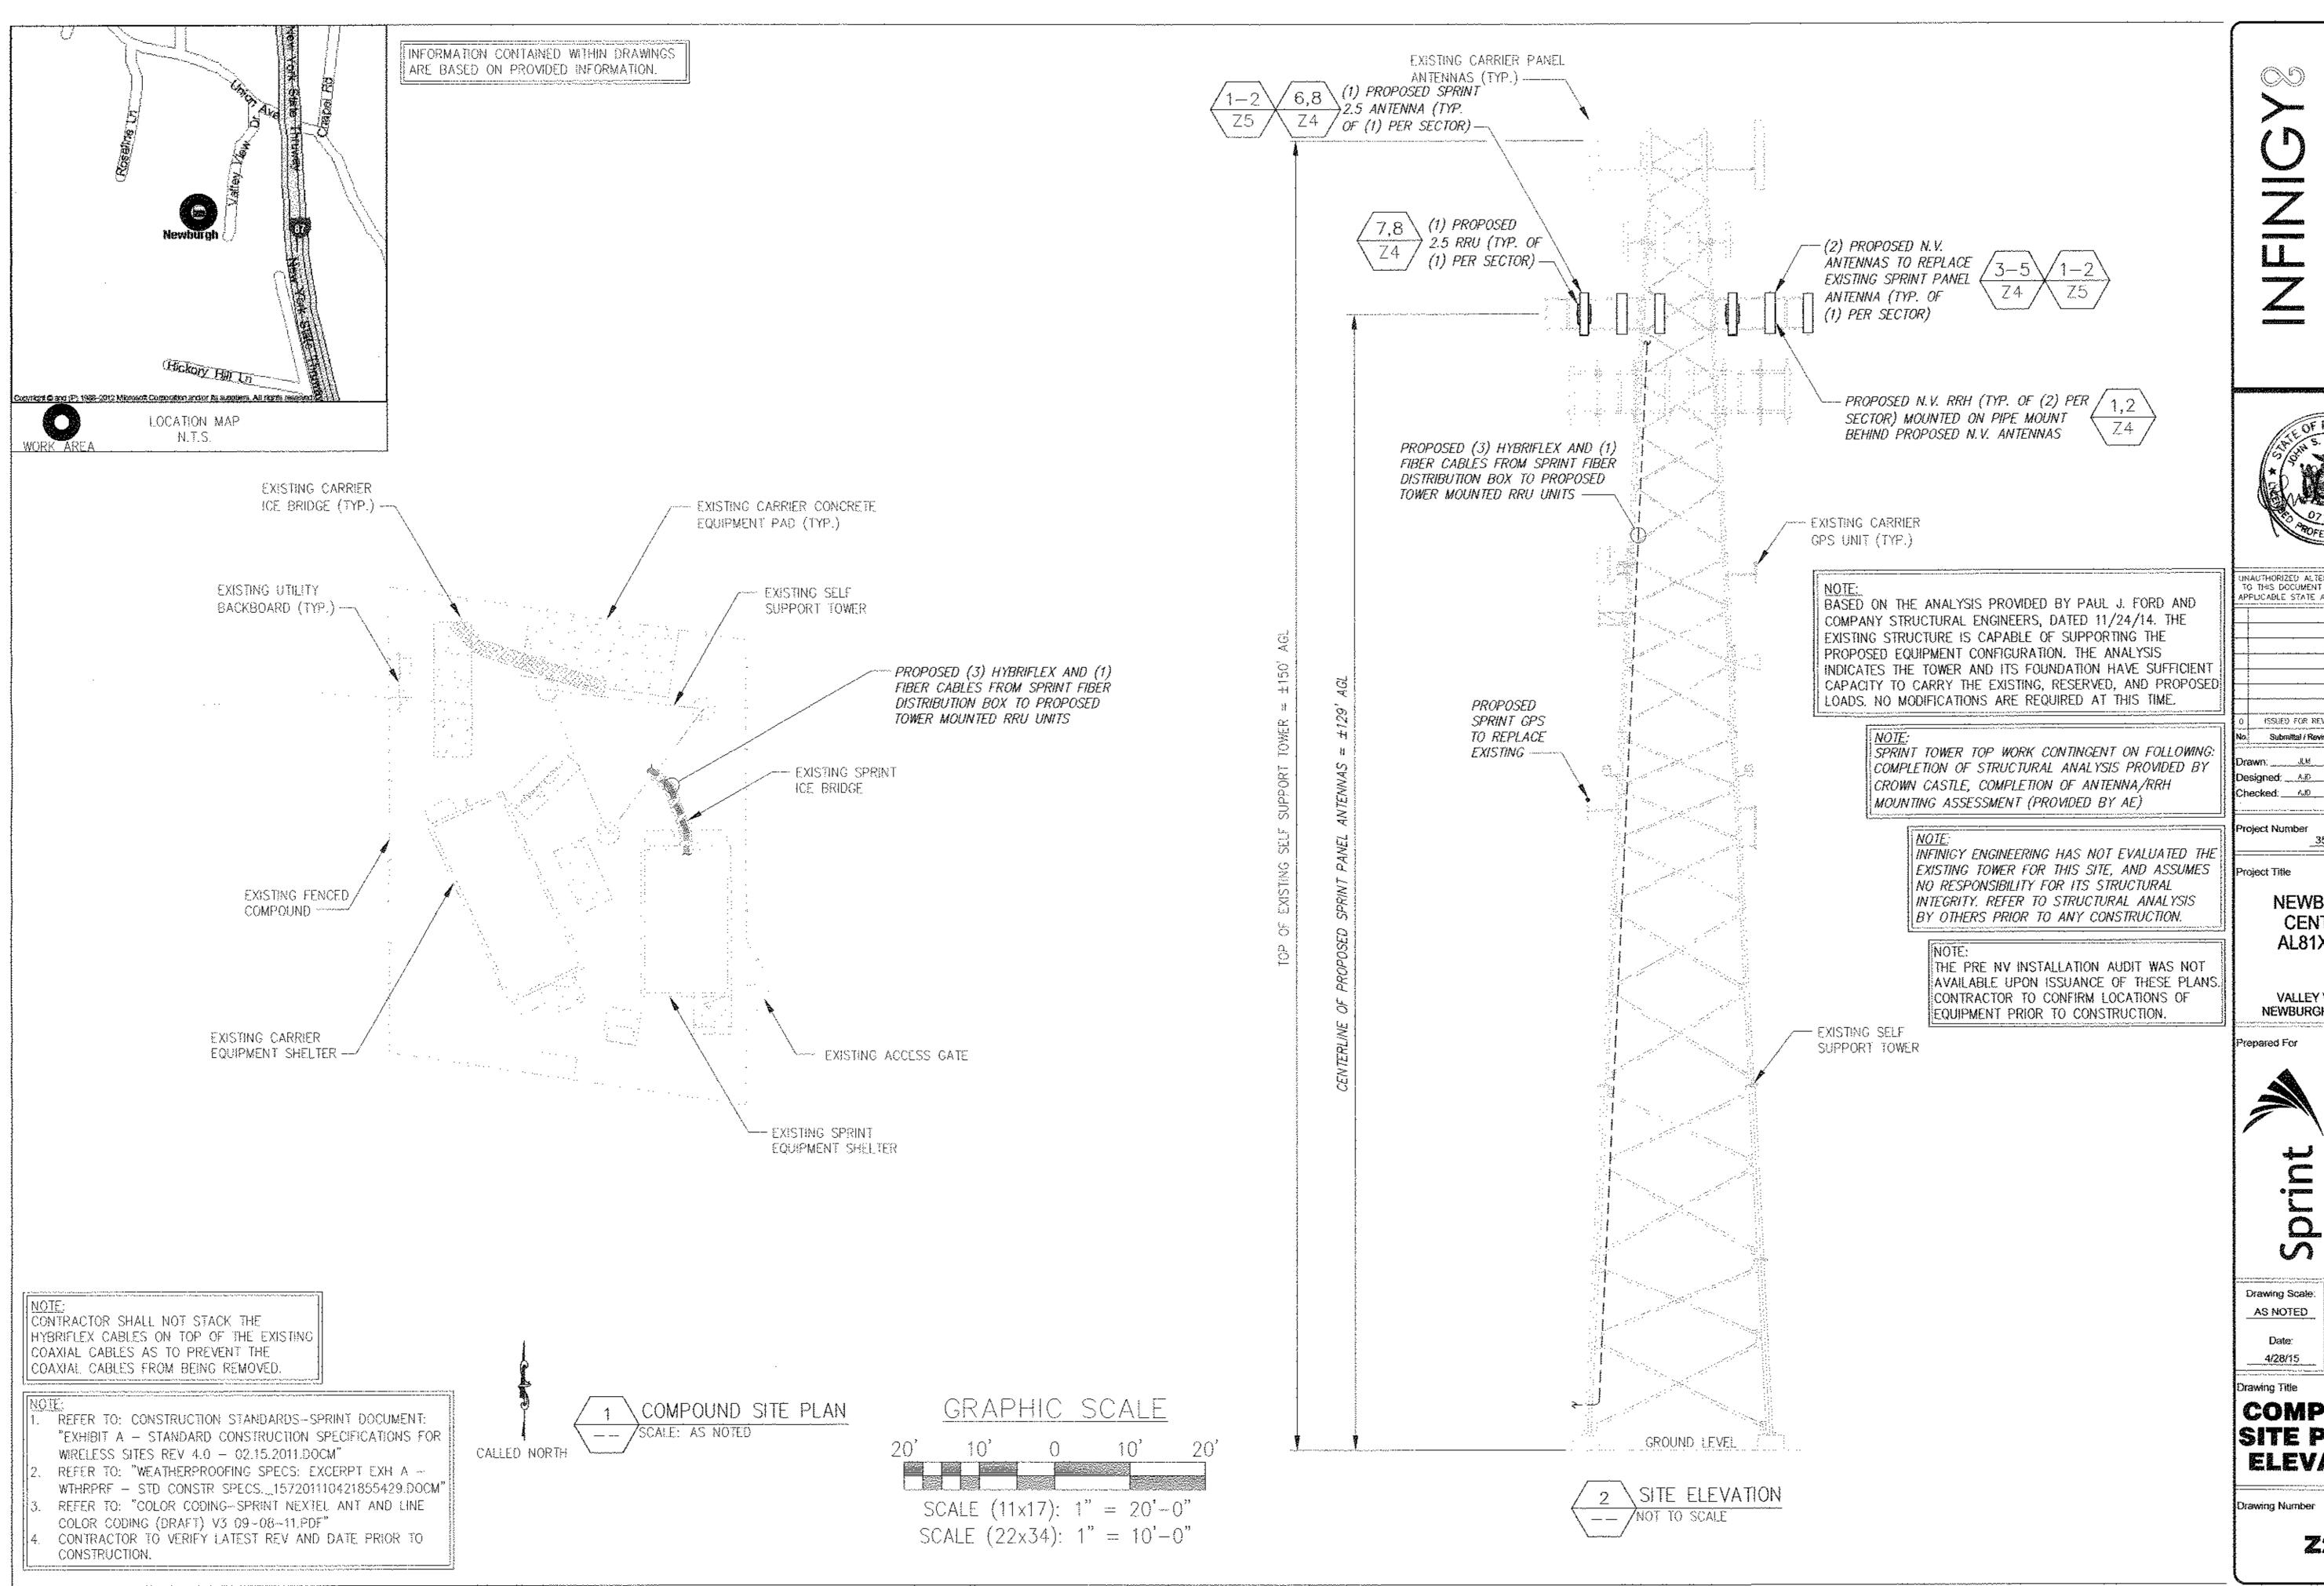

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____JLM___ **Date**:___4/28/15 Designed: AiD Date: 4/28/15 Checked: AJD Date: 4/28/15


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NEWBURGH CENTRAL AL81XC305

VALLEY VIEW DR NEWBURGH, NY 12550

COMPOUND SITE PLAN & ELEVATION

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4. CONTRACTOR TO VERIFY LATEST REV AND DATE PRIOR TO

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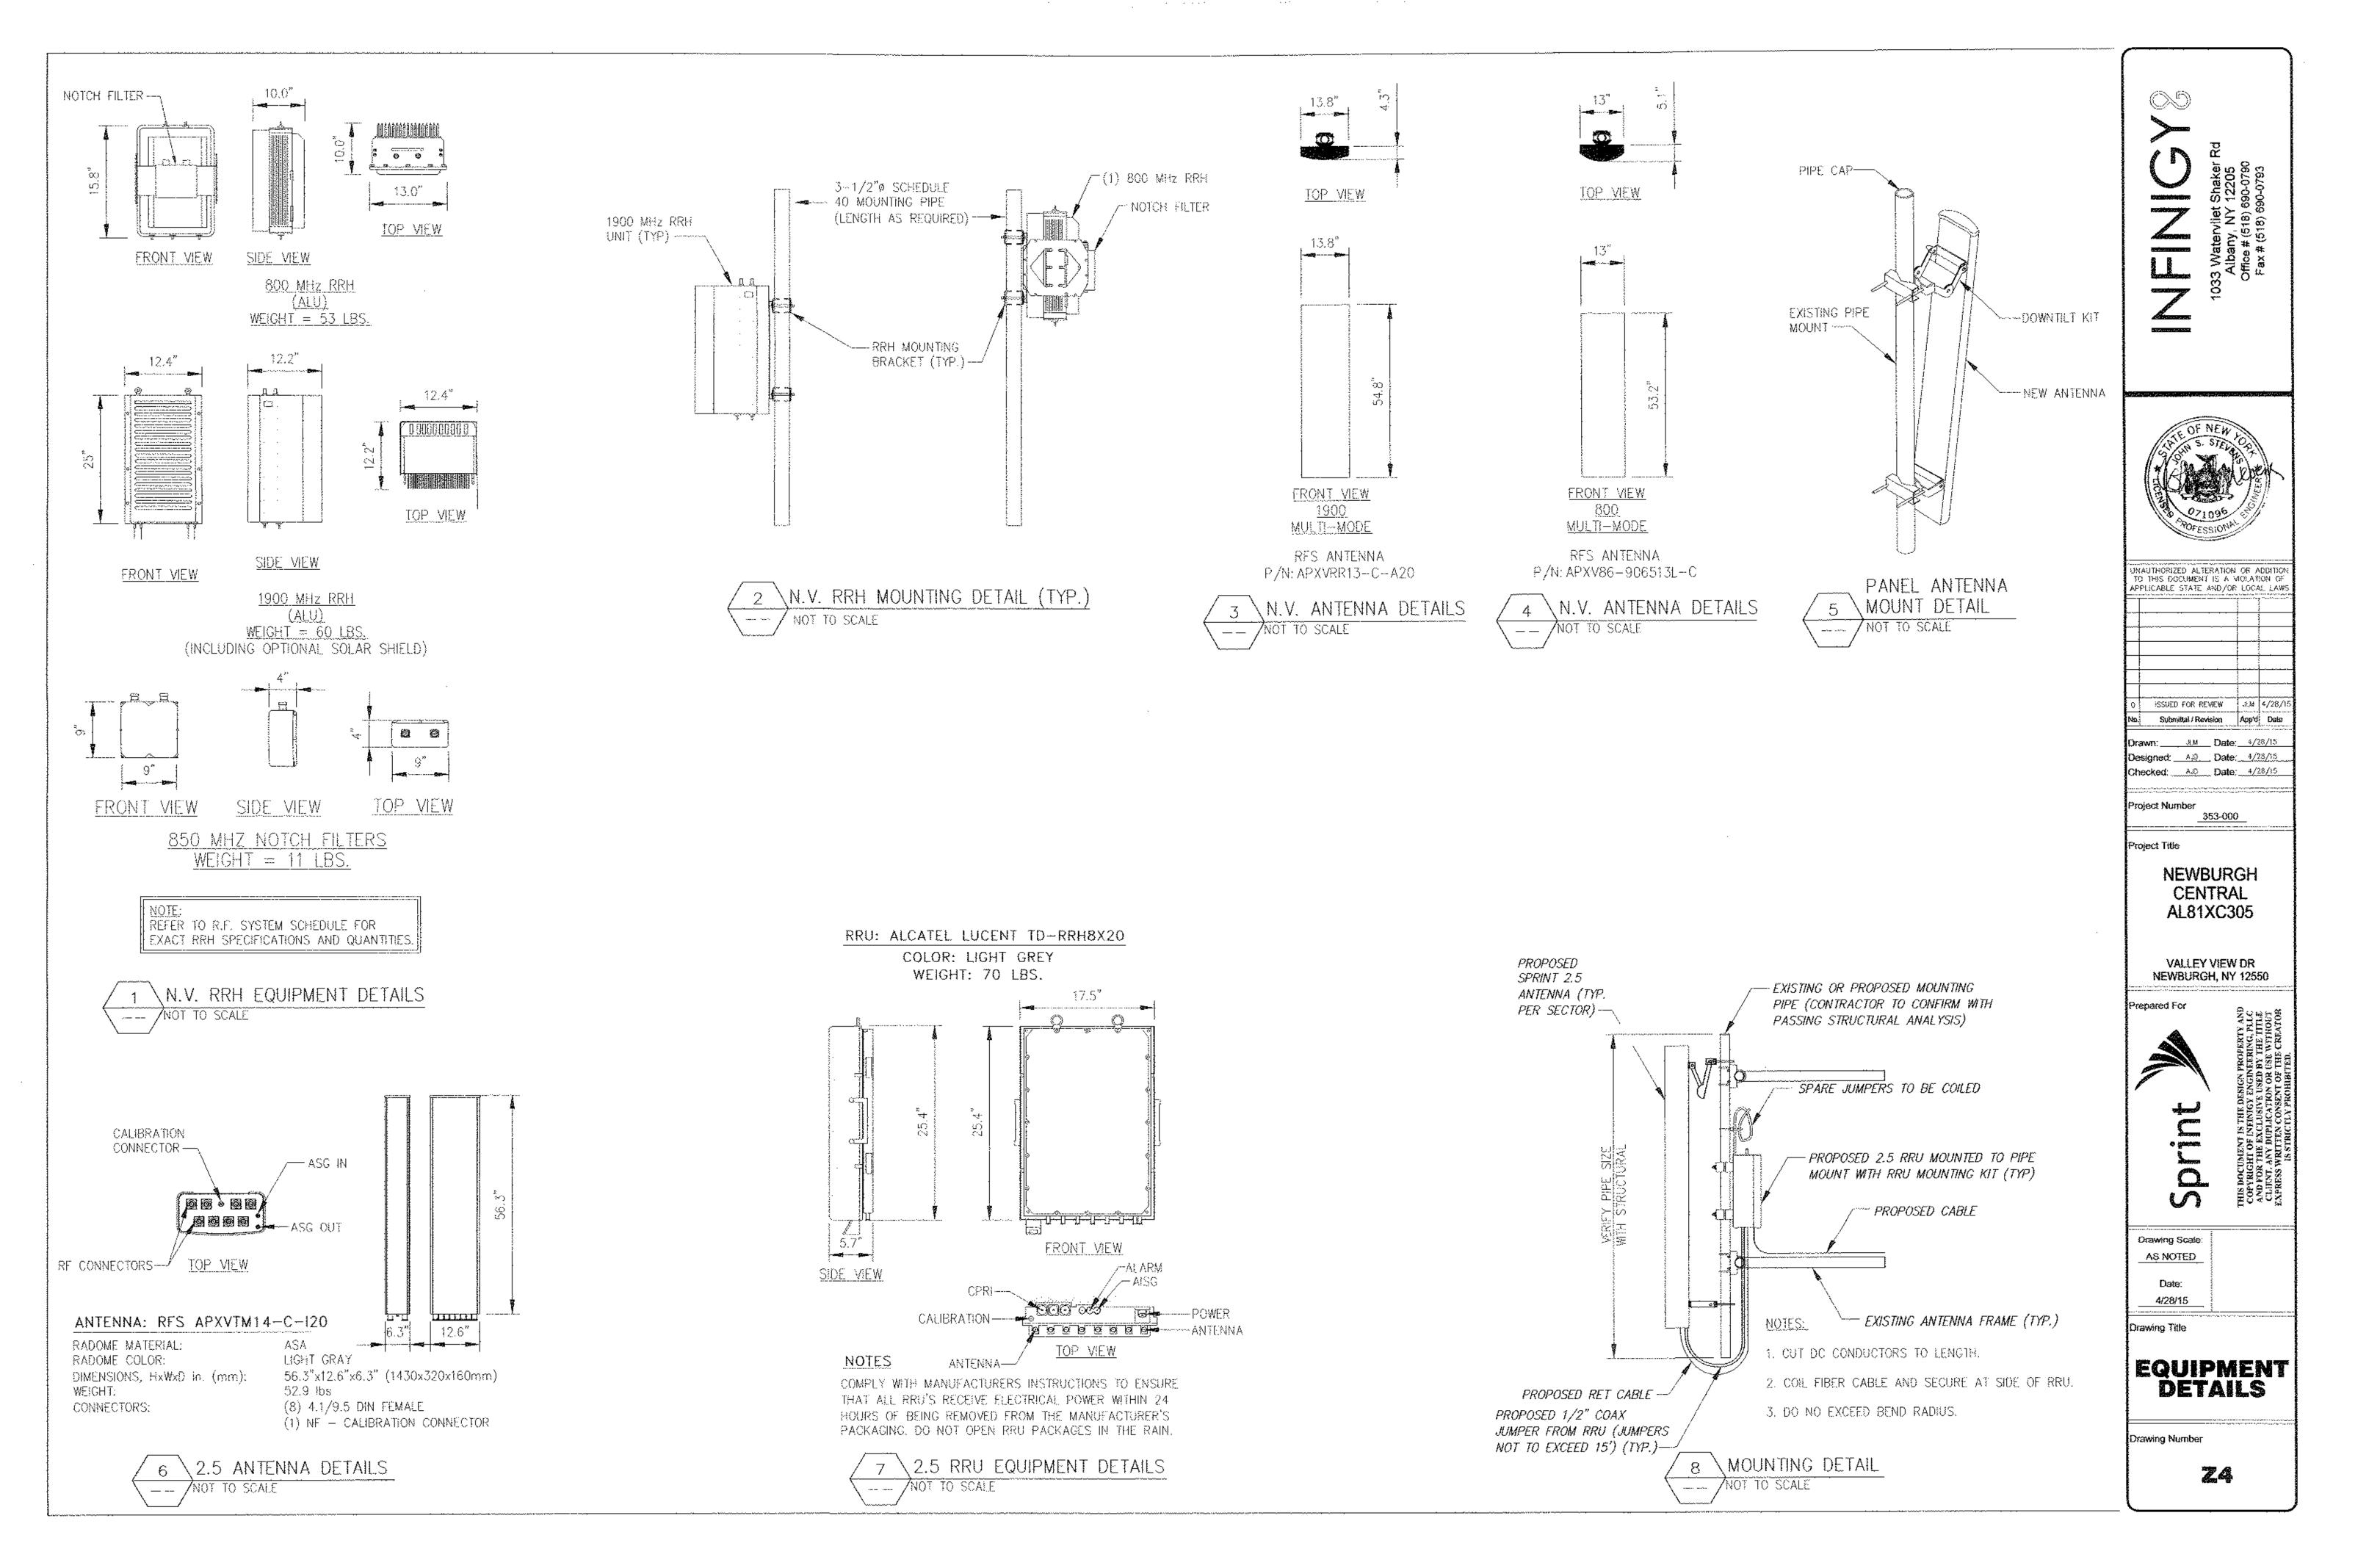
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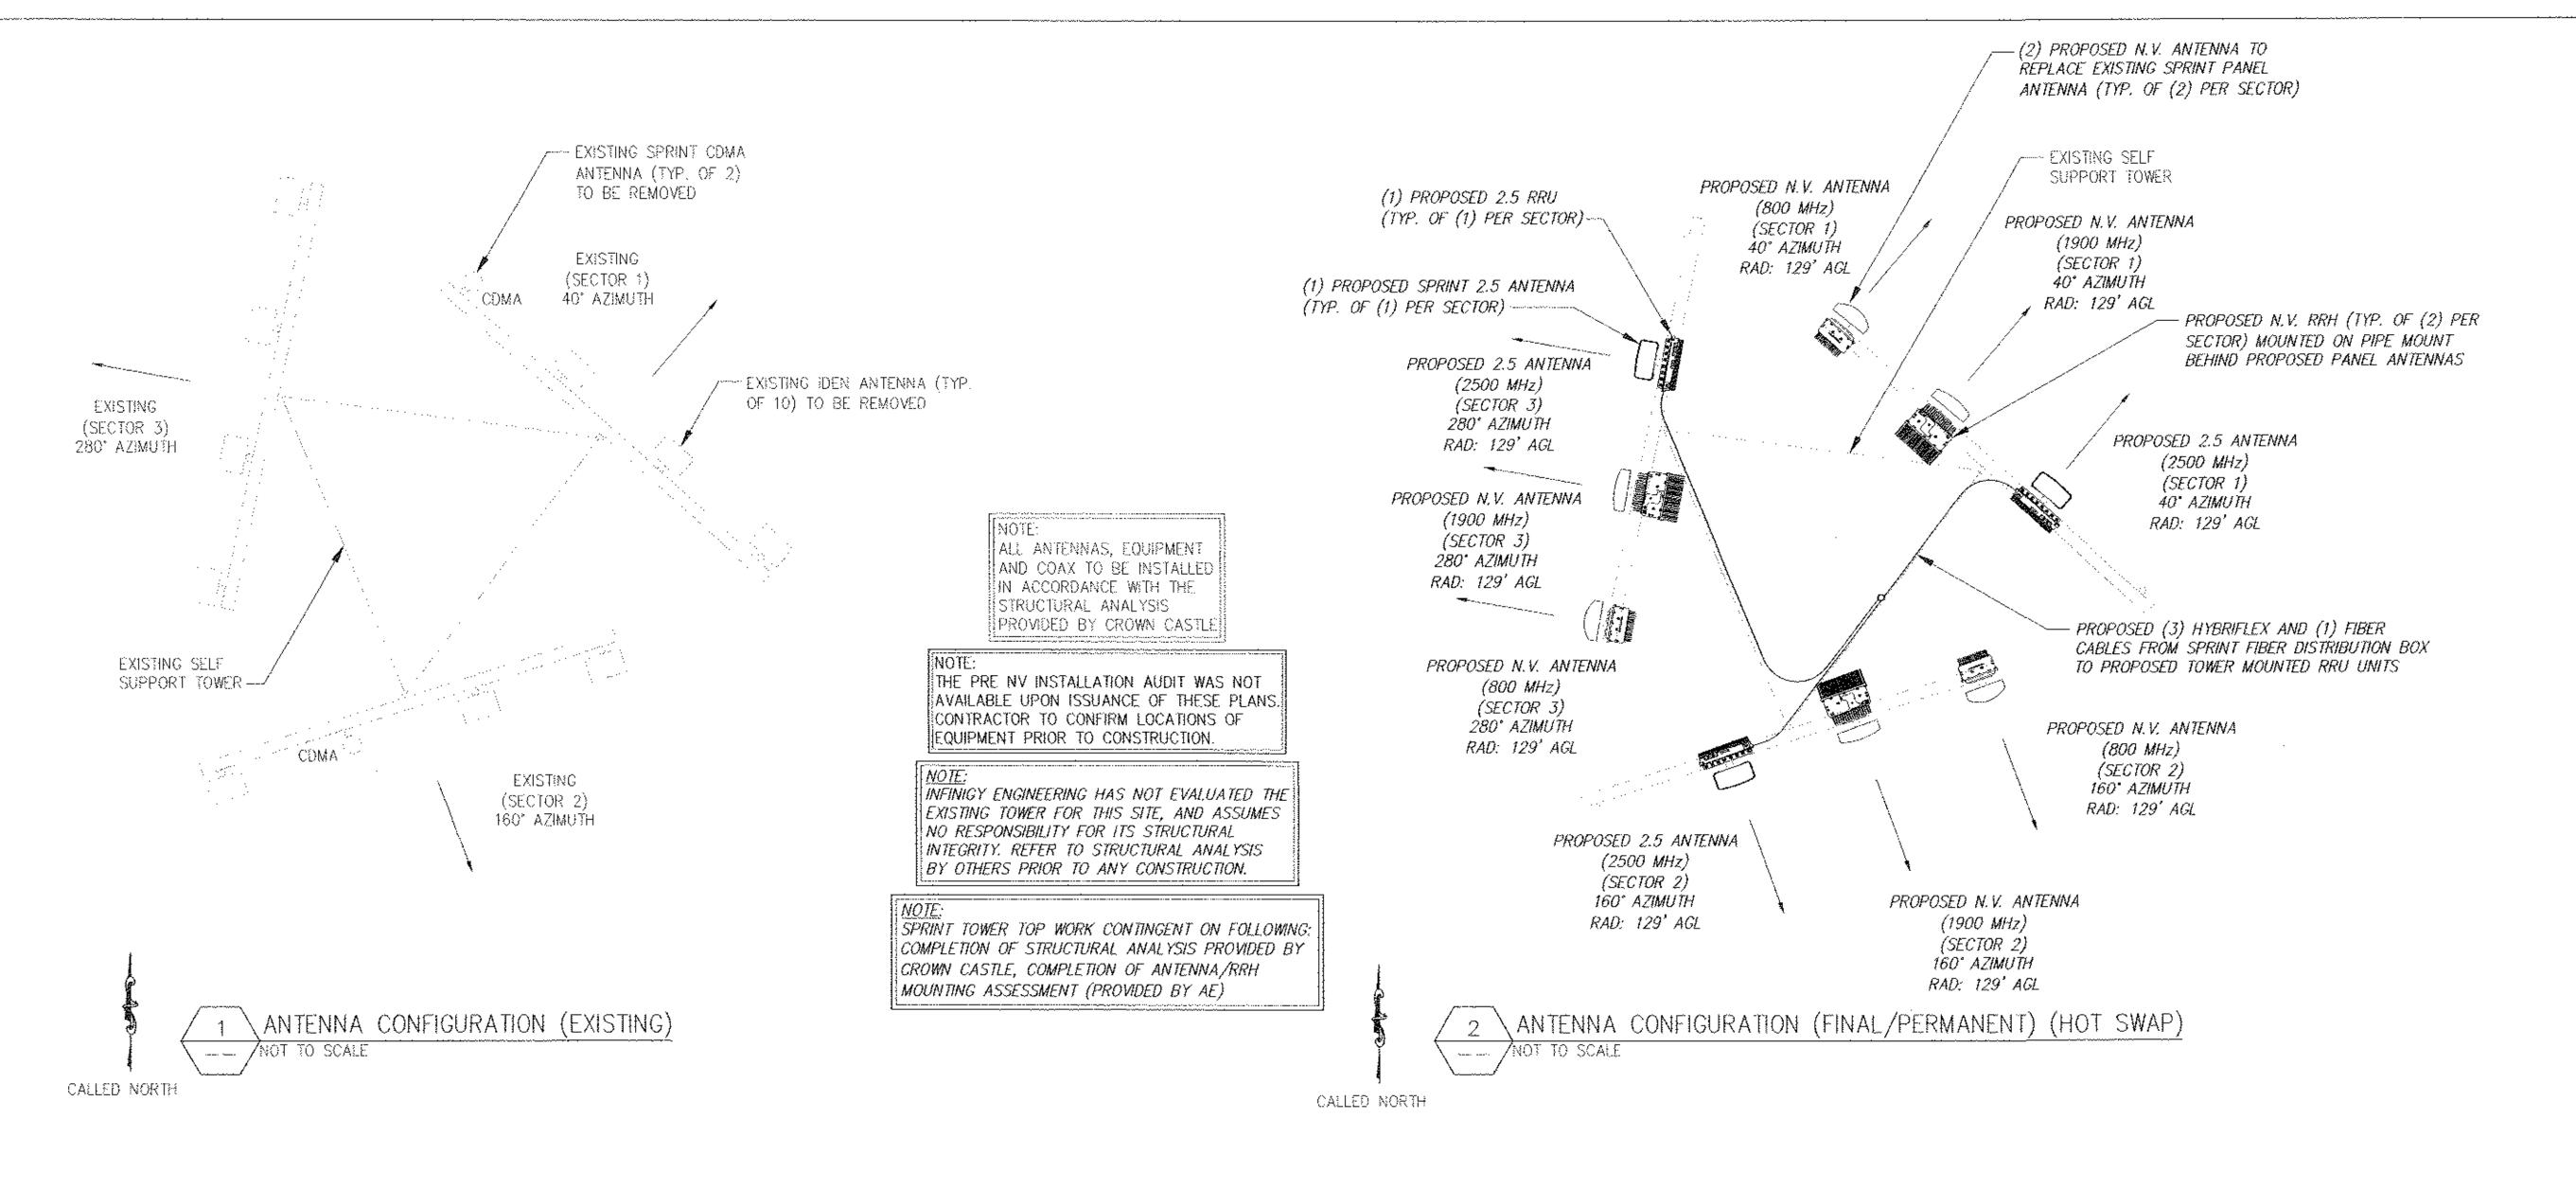
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EQUIPMENT SITE PLANS

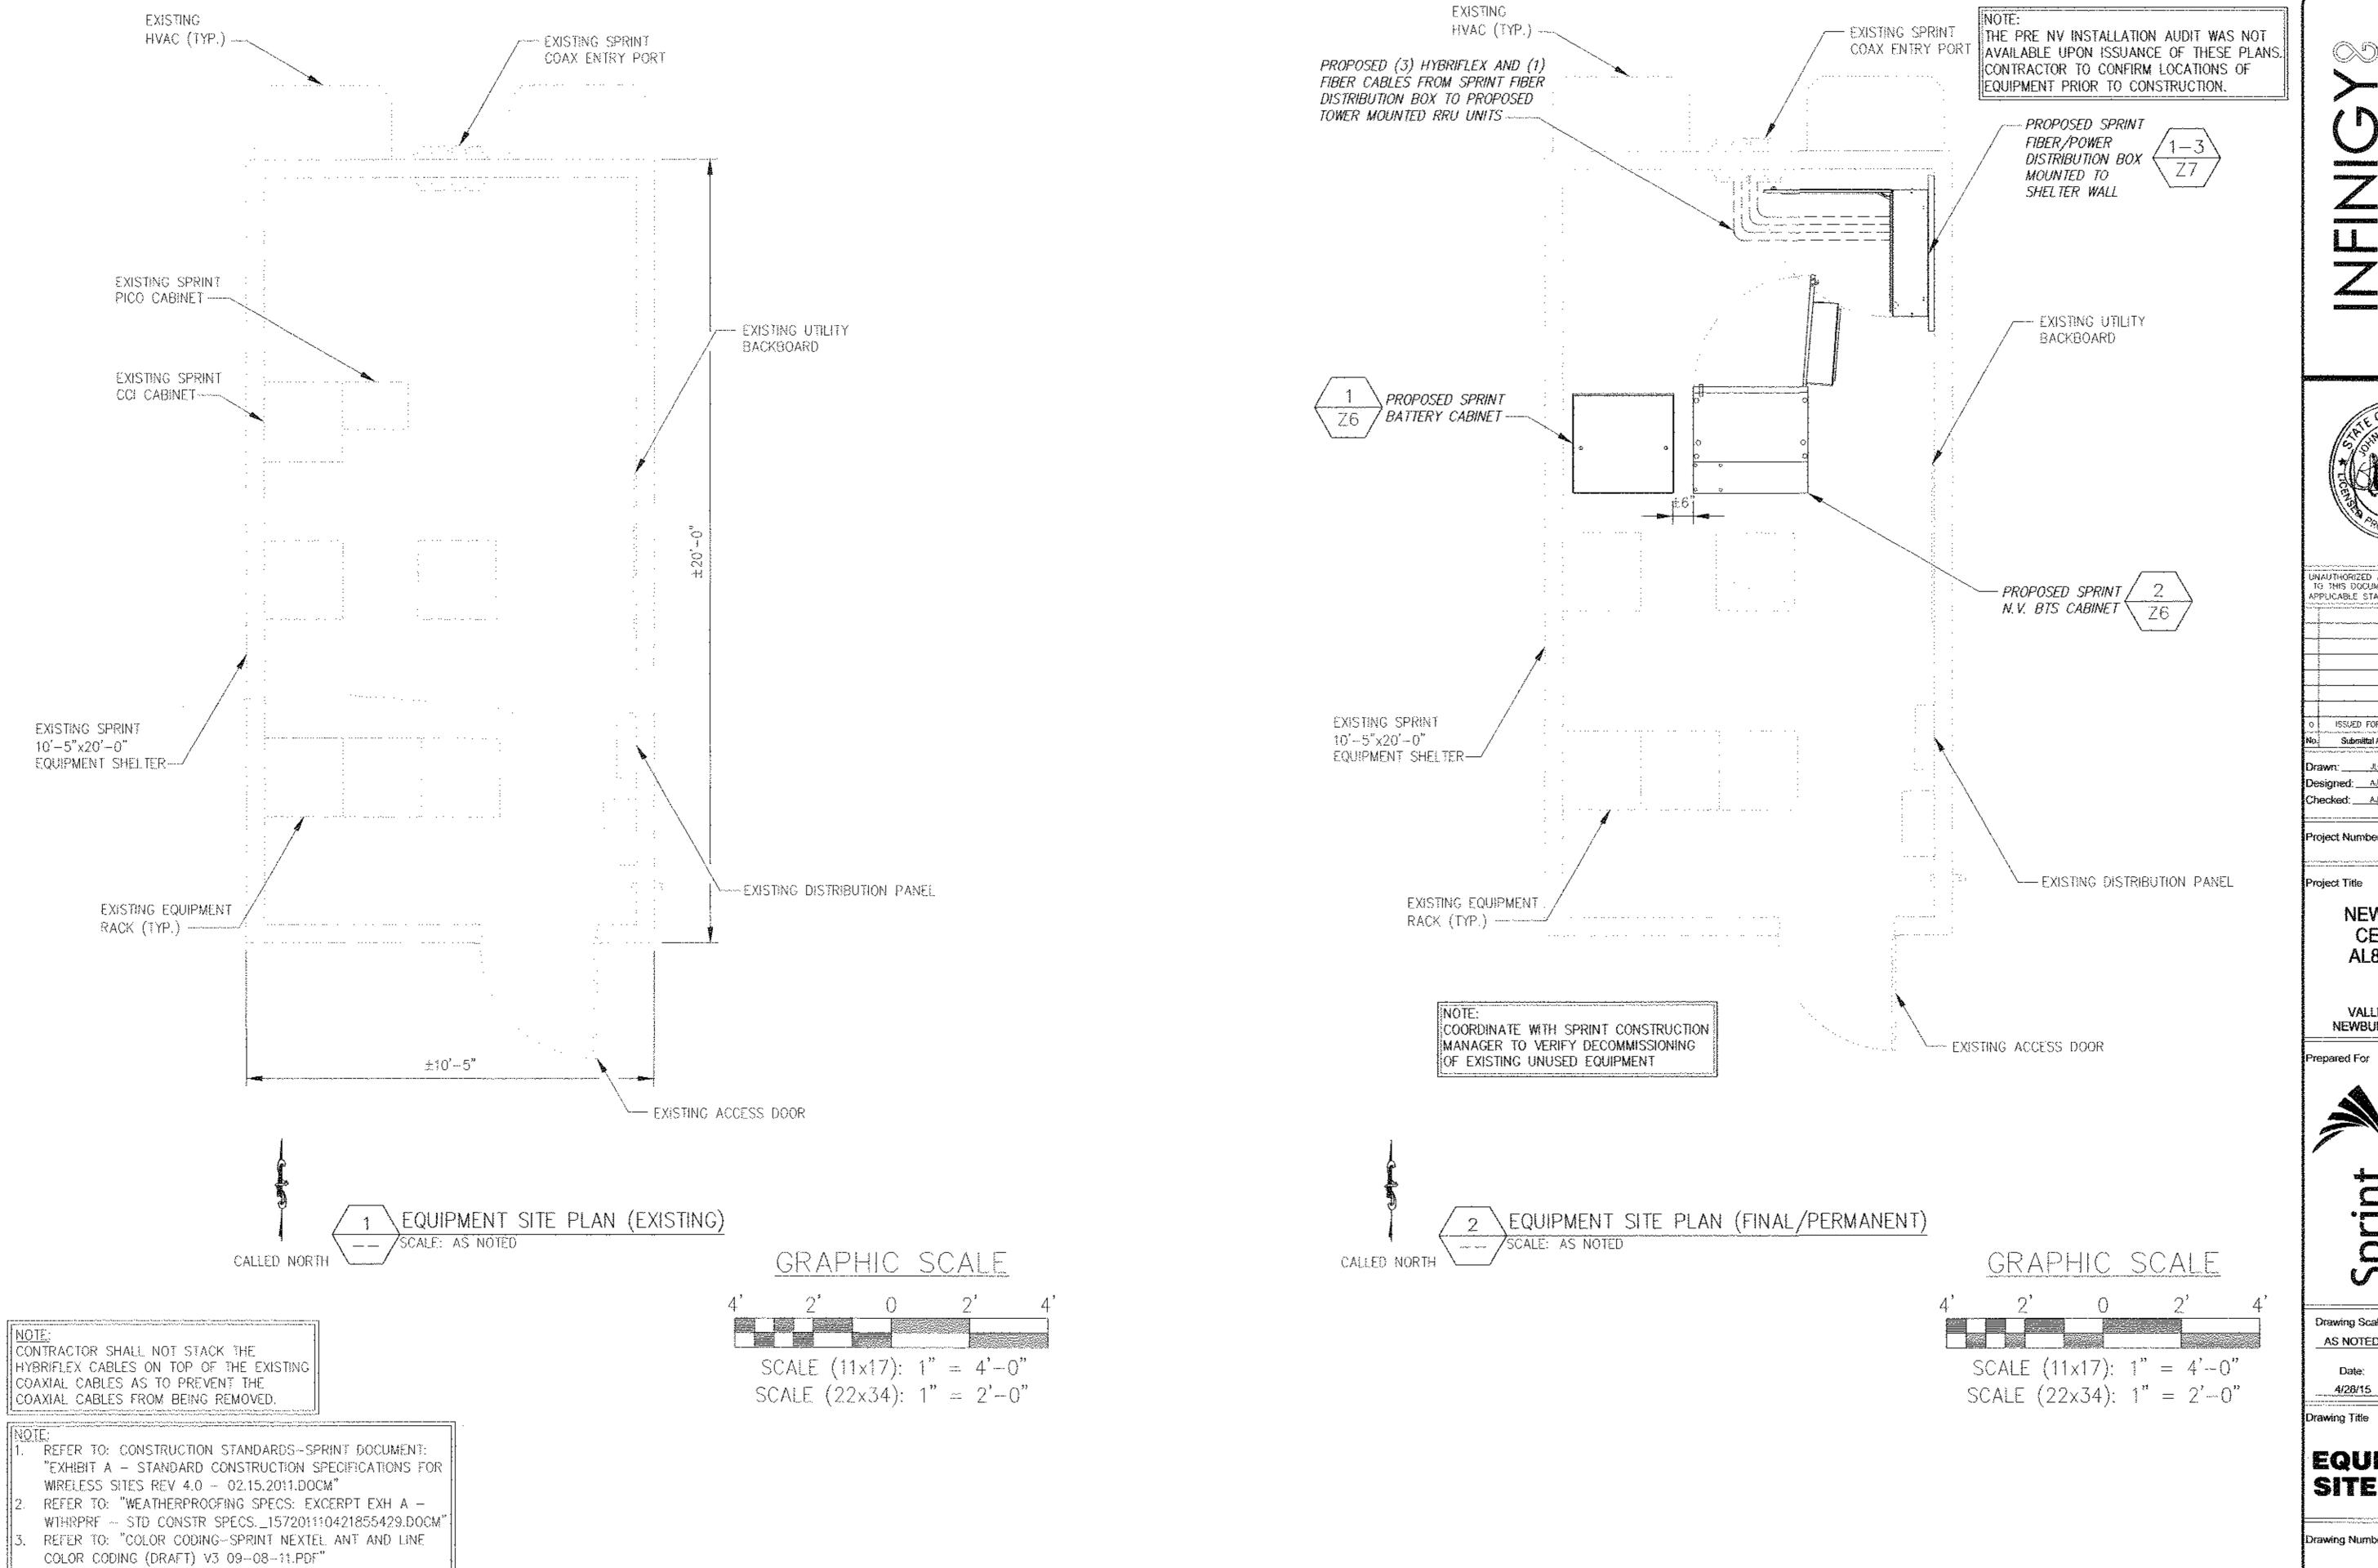Drawing Number





RRH NOTES:

- SEE PAGE C4 FOR RRH MOUNTING INFORMATION (TYP. ALL SECTORS).
- REFER TO RESCHEDULE ON SHEET C7 FOR RRH UNIT SPECS AND QUANTITIES.

GENERAL NOTES:

- 1. NEW SPRINT PANEL ANTENNAS TO MEET RE DESIGN REQUIREMENTS PER EBTS, PER APPROVED STRUCTURAL ANALYSIS.
- 2. CONTRACTOR TO PROVIDE EXISTING ANTENNA VERIFICATION AND TO INCLUDE MOUNTING HEIGHT, RAD CENTER, TOP AND BOTTOM OF ANTENNAS.
- 3. THE CONFIGURATION PLANS ARE FOR CONCEPTUAL PURPOSES ONLY. CONTRACTOR TO VERIFY FIELD CONDITIONS.
- 4. THE ANTENNA INSTALLATION SHALL BE DONE IN ACCORDANCE WITH THE STRUCTURAL ANALYSIS AND ASSOCIATED DETAILS THEREIN. CONTRACTOR SHALL NOTIFY THE ENGINEER OF ANY DISCREPANCIES PRIOR TO WORK ON THE STRUCTURE.
- 5. CONTRACTOR SHALL VERIFY NEW PARTS BEFORE ORDERING.
- 6. REFER TO SHEET C4 & C7 FOR ANTENNA SPECS.
- 7. CONTRACTOR TO USE PROPER TORQUE WHEN INSTALLING AND TIGHTENING CONNECTORS TO INSURE PROPER FIT.
- 8. ALL HYBRID CABLES SHALL BE MARKED WITHIN 24" OF THE END OF EACH CABLE WITH 2" WIDE VINYL TAPE. THIS INCLUDES ALL JUMPERS AND MAIN LINE HYBRID CABLES.
- 9. COMA ANTENNAS SHALL NOT BE REMOVED UNTIL ALL NEW MULTI-MODE ANTENNAS ARE INSTALLED AND ON-AIR.

3 Watervliet Shaker Rd Albany, NY 12205 Office # (518) 690-0790



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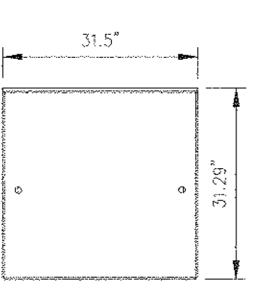
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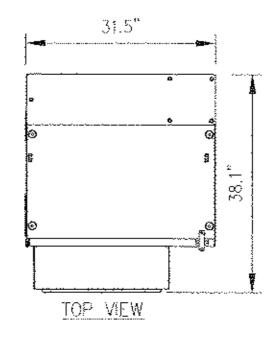
ANTENNA PLANS


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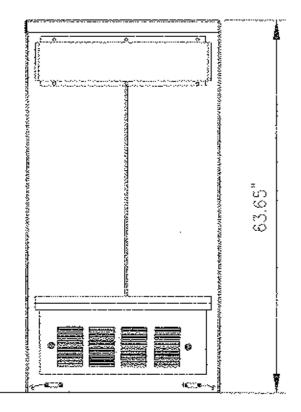
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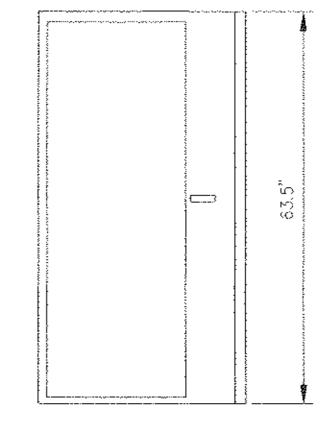
NOTE: REQUIRED PIPE MOUNTS TO BE SUPPLIED BY CONTRACTOR.









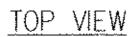

REAR VIEW



2 BTS CABINET PROFILE

FRONT VIEW

<u>DESIGN CRITERIA:</u>	
2009 INTERNATIONAL BUILDING CO	DE W/ STATE MODIFICATION
WIND SPEED (ASCE-7-05)	90 MPA
EXPOSURE B	
IMPORTANCE FACTOR	1.0
SEISMIC SITE CLASS	D
Ss=0.152 S1=0.050	
SEISMIC IMPORTANCE FACTOR	1.0
SEISMIC DESIGN CATEGORY	В
9927 MM BTS CABINET WEIGHT:	594 LBS.
EMERSON BATTERY CABINET SPECI	FICATIONS:
(31.29"x31.5"x63.65")	
WEIGHTS:	
SHIPPING WEIGHT:	600 LBS.
LIFT WEIGHT:	540 L8S.
TOTAL WEIGHT:	2640 LBS (WITH BATTERIES)
INDIVIOUAL BATTERY WEIGHT	: 105 LBS
(DO NOT LIFT WITH BATTI	ERIES IN CABINET)
MATERIAL SPECIFICATIONS	
C-, M-, AND ANGLE SHAPES:	ASTM A36
MIGH-STRENGTH BOLTS:	ASTM A325SC OR (A325N)
STRUCTURAL WE SHAPES:	ASTM A572-GR50
TUBE STEEL & PIPE COLUMNS:	ASTM A500, GRADE B
WELDING ELECTRODES:	E70XX
W - SHAPES:	ASTM A992, GRADE 50
U80£15:	ASTM A36


1. DO NOT USE ONE HOISTING GRIP FOR HOISTING TWO OR MORE CABLES OR CABLE TRAYS. THIS CAN CAUSE THE HOISTING GRIP TO BREAK OR THE CABLES OR WAVE- GUIDES TO FALL.

2. DO NOT USE THE HOISTING GRIP FOR LOWERING CABLE OR CABLE TRAY, SNAGGING OF THE CABLE OR CABLE TRAY MAY LOOSEN THE GRIP AND POSSIBLY CAUSE THE CABLE TO CABLE TRAY TO SWAY OR FALL.

3. DO NOT REUSE HOISTING GRIPS. USED GRIPS MAY HAVE LOST ELASTICITY, STRETCHED, OR BECOME WEAKENED. REUSING A GRIP CAN CAUSE THE CABLE OR CABLE TRAY TO SLIP, BREAK, OR FALL.

4. USE HOISTING GRIPS AT INTERVALS OF NO MORE THAN 200 FT (60 M).

5. MAKE SURE THAT THE PROPER HOISTING GRIP IS USED FOR THE CABLE OR CABLE TRAY BEING INSTALLED, SLIPPAGE OR INSUFFICIENT GRIPPING STRENGTH WILL RESULT IF YOU ARE USING THE WRONG HOISTING GRIP.

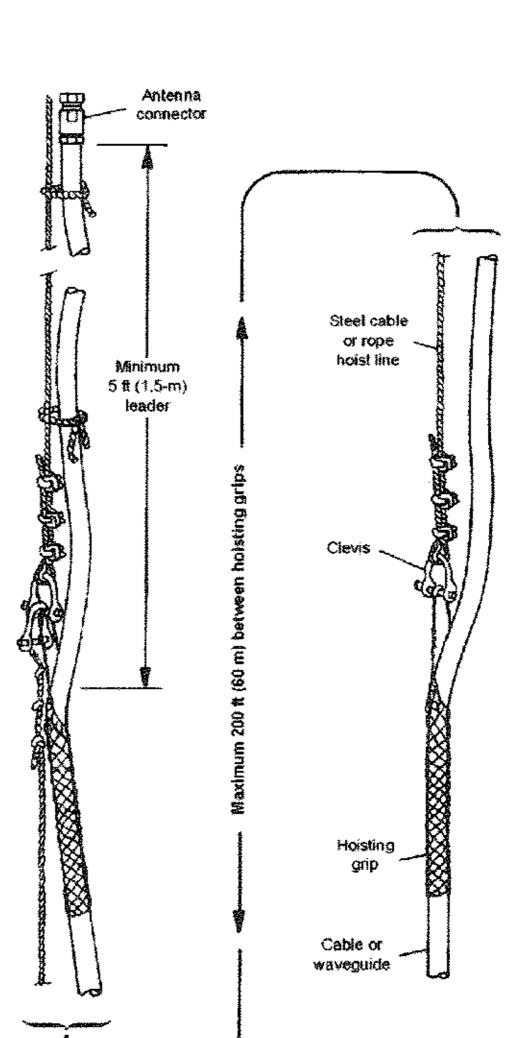

3 HOIST GRIP DETAIL.

-- NOT TO SCALE

NOTE:

- 1. REFER TO: CONSTRUCTION STANDARDS—SPRINT DOCUMENT:
 "EXHIBIT A STANDARD CONSTRUCTION SPECIFICATIONS FOR WIRELESS SITES REV 4.0 02.15.2011.DOCM"
- 2. REFER TO: "WEATHERPROOFING SPECS: EXCERPT EXH A WITHRPRF STD CONSTR SPECS._157201110421855429.DOCM"
- 3. REFER TO: "COLOR CODING-SPRINT NEXTEL ANT AND LINE COLOR CODING (DRAFT) V3 09-08-11.PDF"
- 4. CONTRACTOR TO VERIFY LATEST REV AND DATE PRIOR TO CONSTRUCTION.

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NEWBURGH CENTRAL AL81XC305

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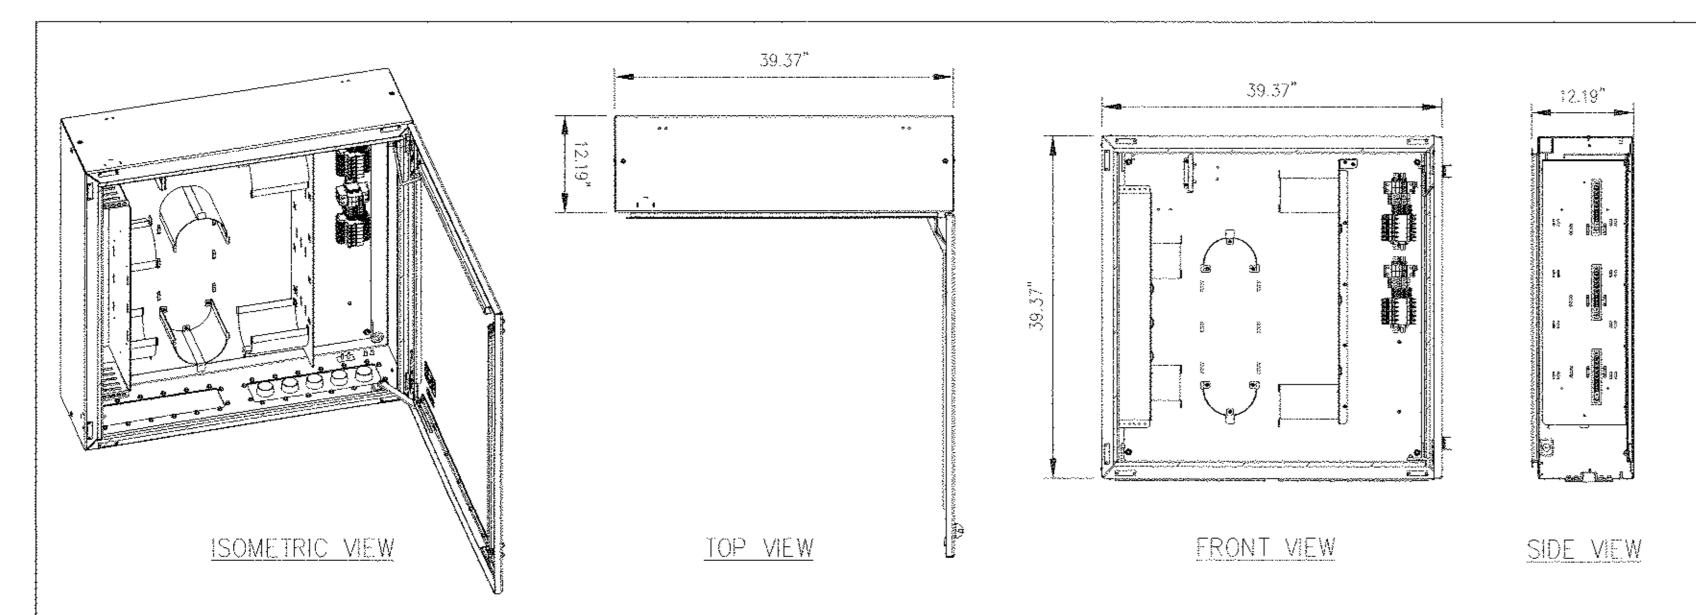
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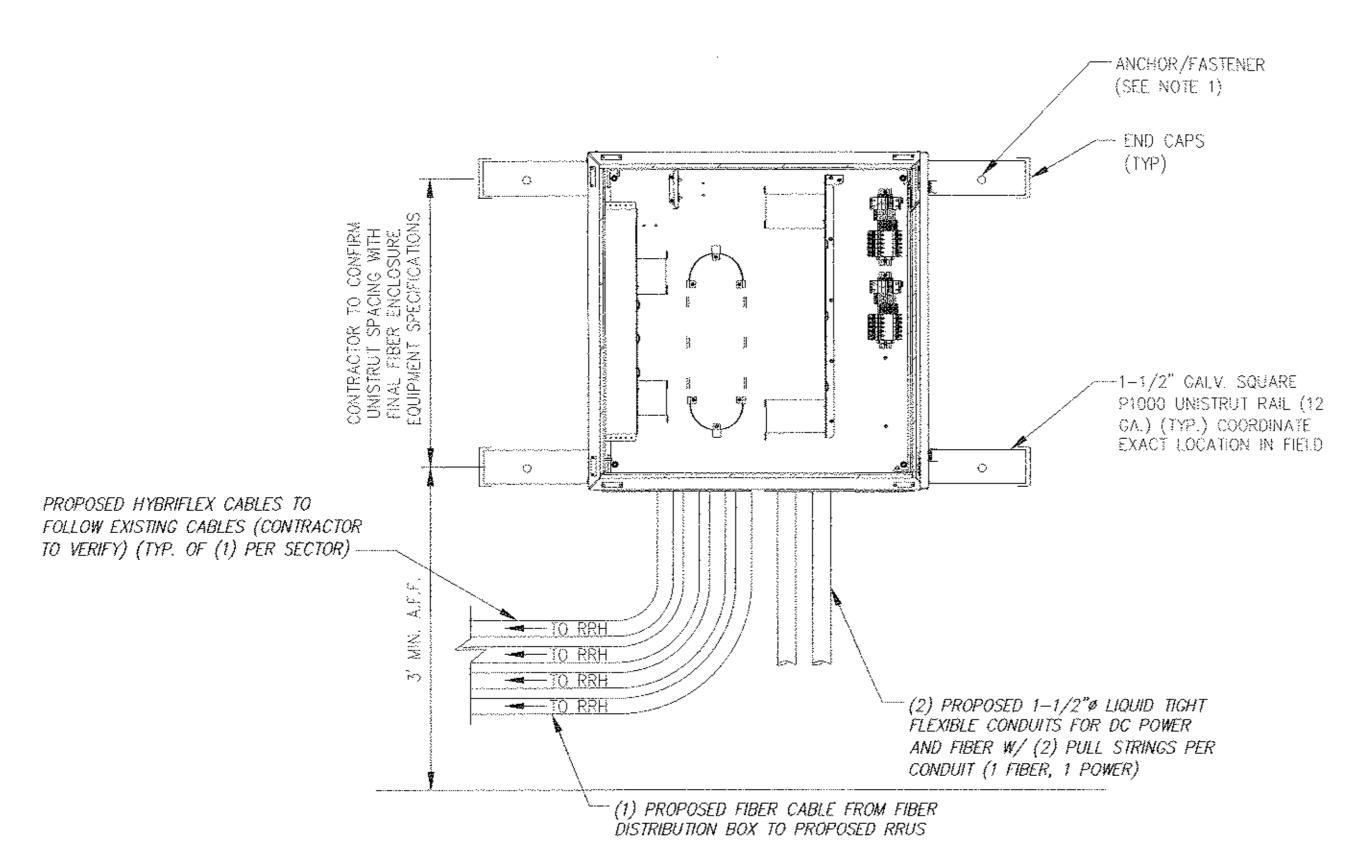
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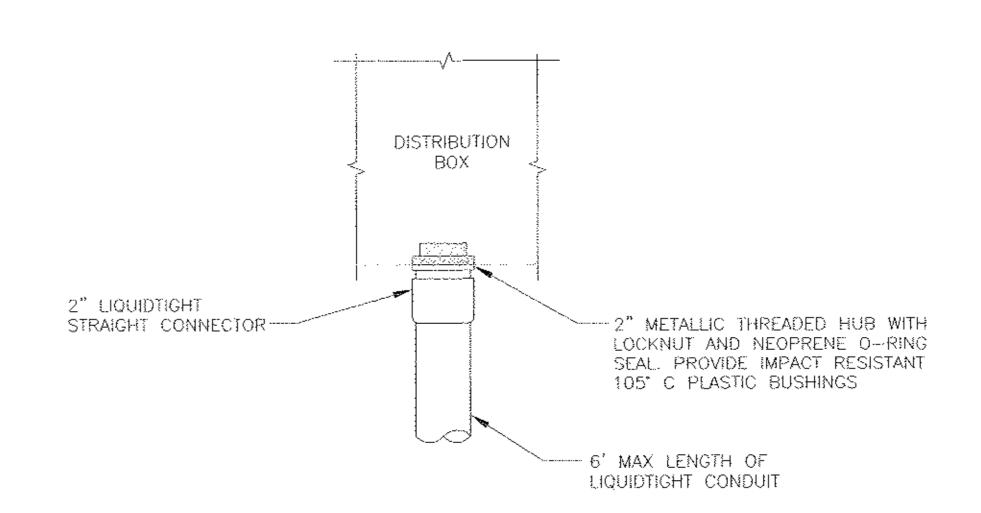
DISTRIBUTION BOX DETAIL NOT TO SCALE




- WOOD STUDS 1/4"ø LAG BOLT W/ 1" EMBEDMENT IN WOOD
- ◆ THROUGH BOLT 1/4"Ø A36/A307 THREADED ROD W/ NUTS AND WASHERS

3. MOUNT FIBER AND POWER DISTRIBUTION BOX WITH FOUR (4) 1/4" WINISTRUT BOLTING HARDWARE AND SPRING NUTS.

DISTRIBUTION BOX ON EXISTING WALL -- / NOT TO SCALE



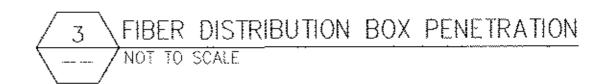





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DISTRIBUTION **BOX DETAILS**

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- DISTRIBUTION BOX IS KITTED WITH 50' OF 1-1/2" LIQUID-TIGHT CONDUIT AND CONNECTORS. THIS SHOULD 8E:

* SPLIT IN HALF,

* TERMINATED TO THE DISTRIBUTION BOX AS SHOWN, * RAN TO AND COILED AS CLOSE TO WHERE THE CABINET IS GOING TO BE MOUNTED AS POSSIBLE.

- DISTRIBUTION BOX IS KETTED WITH 2 AWG, POWER CABLE. 35' x 2EA, RUNS RED AND 2EA, RUNS BLACK, THIS SHOULD BE COILED AND LEFT INSIDE DISTRIBUTION BOX.

- BTS INSTALLATION TEAM WILL TERMINATE LIQUID-TIGHT, RUN THE FIBER JUMPERS AND POWER CABLES FROM BTS CABINET TO DISTRIBUTION BOX.

INSTALL ANCHORS/FASTENERS A MAXIMUM OF 2'-0" ON CENTERS.

● CONCRETE - 1/4"Ø HRTI KWK BOLT # W/ 1-1/2" EMBEDMENT OR EQUIVALENT

ANCHORS AND UNISTRUT CHANNEL SHALL HAVE HOT-DIPPED CALVANIZED FINISH.

RFS HYBRIFLEX RISER CABLE SCHEDULE


nly Power)	Hybrid cable MN: H8058-M12-050F 12x multi-mode fiber pairs, Top: Outdoor protected connectors, Bottom: EC Connectors, 5/8 cable, 50 ft	50 ft
Fiber Only ting DC Po	MN; H8058-M12-075F	75 ft
<u>a</u>	MN: HB058-M12-100F	100 ft
Fibe (Existing	MN: HB058-M12-125F	125 ft
ž	MN: HB058-M12-150F	150 ft
₩.	MN: H8058-M12-175F	175 ft
	MN: HB058-M12-200F	1200 ft
	Hybrid cable MN: HB114-08U3M12-050F	
8 AWG Power	3x 8 AWG power pairs, 12x multi-mode fiber pairs, Outdoor rated connectors & LC Connectors, 1 1/4 cable, 50 ft	50 ft
Ô	MN: HB114-08U3M12-075F	75 ft
S	MN: HB114-08U3M12-100F	100 ft
₹	MN: HB114-08U3M12-125F	125 ft
8 A	MN: HB114-08U3M12-150F	150 ft
	MN: HB114-08U3M12-175F	175 ft
	MN: HB114-08U3M12-200F	200 ft.
6 AWG Power	Hybrid cable MN: HB114-13U3M12-22SF 3x 6 AWG power pair, 12x multi-mode fiber pairs, Outdoor rated connectors & t.C. Connectors 1 1/4 cable 225 ft	225 ft
ջ	MN: HB114-13U3M12-250F	250 ft
<u> </u>	MN: HB114-13U3M12-275f	275 ft
<u> </u>	MN: HB114-13U3M12-300F	300 ft
<u> </u>		1
AWG Power	Hybrid cable MN: H8114-21U3M12-325F 3x 4 AWG power pair, 12x multi-mode fiber pairs, Outdoor rated connectors & LC Connectors, 1 1/4 cable, 325 ft	325 ft
₹	MN: HB114-21U3M12-350F	350 ft
4	MN: HB114-21U3M12-375F	375 ft

RFS HYBRIFLEX JUMPER CABLE SCHEDULE


	Hybrid Jumper cable		12
Fiber Only	MN: HBF012-M3-5F1	5 ft	
	5 ft, 3x multi-mode fiber pairs, Outdoor & LC connectors, 1/2 cable	1 31 8	
	MN: HBF012-M3-10F1	10 ft	
	MN: H85012-N3-1551	15 ft	
	MN:H8F012-M3-20F1	20 ft	
	MN: HBF012-M3-25F1	25 ft	
	MN: H8F012-M3-30F1	30 (t	
8 AWG Power	Hybrid Jumper cable		
	MN:H8F058-08U1M3-5F1	5 ft	
	5 ft, 1x 8 AWG power pair, 3x multi-mode fiber pairs, Outdoor & LC Connectors.	\$ 1°£	
	5/8 cable		
	MN: HBF058-08U1M3-10F1	1 0 ft	
	MN: H8F058-08U1M3-15F1	1 5 ft	12
	MN: H8F058-08U1M3-20F1	20 ft	
	MN: HBF058-08U1M3-25F1	25 ft	
	MN: H8F058-08U1M3-30F1	30 ft	
6 AWG Power	Hybrid Jumper cable		
	MN: HBF058-13U1M3-5F1	5 ft	
	5 ft, 1x 6 AWG power pair, 3x multi-mode fiber pairs, Outdoor & LC Connectors,	310	
	5/8 cable		
	MN: HBF858-13U1M3-10F1	10 ft	
	MN: H8F058-13U1M3-15F1	15 ft	
	MN: M8F058-13U1M3-20F1	20 ft	
	MN: H8F058-13U1M3-25F1	25 ft	I INS
	MN: H8F058-33U1M3-30F1	30 ft	
· · · · · · · · · · · · · · · · · · ·			3
	Hybrid Jumper cable		
	MN: HBF078-21U1M3-5F1	\$ ft	
AWS Power	5 ft, 1x 4 AWG power pair, 3x multi-mode fiber pairs, Outdoor & tC Connectors,		
	7/8 gable	10 fr	
φ ≥	MN: HBF078-21U1M3-10F1	10 ft	
4 4 5	MN: H8F078-21U1M3-15F1.	15 ft	
	MN: HBF078-21U1M3-20F1	20 ft	
	Mn: HBF078-21U1M3-25F1	25 ft	
	[MN; HBF078-21U1M3-30F1	30 ft	

NOTE:
SPRINT CM TO CONFIRM HYBRID OR FIBER
RISER CABLE AND HYBRID OR FIBER JUMPER
CABLE MODEL NUMBERS IF HYBRID CABLES
ARE REQUIRED BEFORE PREPARING BOM.



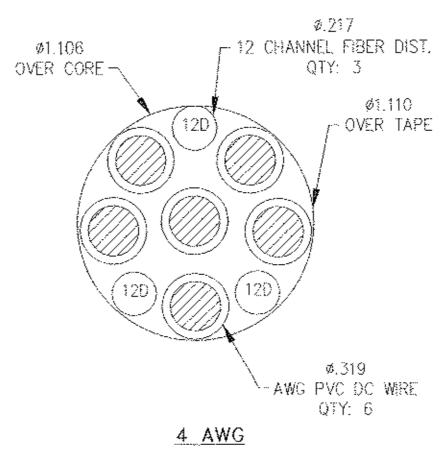

8 & 6 AWG

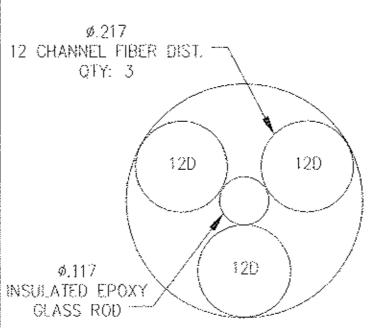

FIBER ONLY

3 Watervliet Shaker Rd Albany, NY 12205



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