

TOWN OF NEWBURGH PLANNING BOARD TECHNICAL REVIEW COMMENTS

PROJECT NAME:CBPS REALTY INC.PROJECT NO.:2021-13PROJECT LOCATION:SECTION 34, BLOCK 2, LOT 29.1REVIEW DATE:14 JANUARY 2022MEETING DATE:20 JANUARY 2022PROJECT REPRESENTATIVE:LANC & TULLY ENGINEERING

- 1. A detailed plan has been submitted identifying items which were discussed during a Technical Work Session. The full build out of the project has been depicted on the plans. Extensive retaining walls are proposed on the site. Top and bottom wall elevations should be specified on future submissions. Materials for the retaining walls should be identified.
- 2. One hundred foot buffer has been proposed along the east property line.
- 3. NYSDOT approval for the site access drive will be required.
- 4. Orange County Planning submission will be required upon submission of detailed plans.
- 5. Lighting on the site should be addressed in future submissions.
- 6. A Stormwater Pollution Prevention Plan is required to be prepared for the site. Stormwater management facility is depicted along the western property line. Concern regarding point discharge to the adjoining property owners should be addressed.
- 7. Is project required to obtain coverage under a Multi-Sector General Stormwater Permit? If so, this should be addressed in the SWPPP prepared for the project.
- 8. The project is proposed to be served by a well. Recent 2020 Building Code Section P2602 identifies that any building or premise where plumbing fixtures are installed <u>shall</u> be connected to a public water supply. This comment should be addressed with the Town Code Enforcement Office. Jim Campbell's comments regarding the installation of the well within the water district should be received.
- 9. The design of the subsurface sanitary sewer disposal system must be provided.
- 10. Two Types of retaining wall are depicted on the plans. Type of retaining wall should be depicted on the plan sheets in all locations.
- 11. It is noted a fence appears on the Site Plan. Details of the fence should be included on the plans.

NEW YORK OFFICE

PENNSYLVANIA OFFICE 111 Wheatfield Drive, Suite 1, Milford, PA 18337 570-296-2765 | F: 570-296-2767 | mhepa@mhepc.com

- 12. Any drainage facilities proposed to convey runoff to the treatment areas should be depicted on plans. Bio-retention areas are required to be protected with some form of pre-treatment for sediment.
- 13. A revised Long Form EAF should be submitted to incorporate changes to the plan including the limits of disturbance at 12.5 acres. Project is a Type I Action.
- 14. Landscaping Plans should be provided for the site and also to address the requirement to screen outdoor storage.

Respectfully submitted,

MHE Engineering, D.P.C.

Patrit & Aferes

Patrick J. Hines Principal

PJH/kbw

LANC & TULLY ENGINEERING AND SURVEYING, P.C.

John J. O'Rourke, P.E., Principal David E. Higgins, P.E., Principal John Queenan, P.E., Principal Rodney C. Knowlton, L.S., Principal Jerry A. Woods, L.S., Principal John D. Russo, P.E., Principal John Lanc, P.E., L.S. Arthur R. Tully, P.E.

December 29, 2021

Mr. John Ewasutyn, Chairman Town of Newburgh Planning Board 21 Hudson Valley Professional Plaza Newburgh, NY 12550

> RE: Application for Site Plan CBPS Realty, LLC NYS Route 32 – SBL: 34-2-29.1 Town Application # 2021-13

Dear Chairman Ewasutyn,

On behalf of the applicant, CBPS Realty, LLC, enclosed please find Fourteen (14) copies of the following materials for review at the next available Planning Board agenda:

• Site Plan entitled "CBPS Realty, LLC" last revised December 29, 2021 as prepared by Lanc and Tully, P.C.

The application was last before the Planning Board for conceptual site plan discussion in August 2021. There were numerous questions raised by the Planning Board during the site plan review and a consultant work session was held to review site plan in August 2021. The site plan has been revised based upon consultation with the applicant and the discussions at the meeting with the Town Consultants.

The subject property is located along NYS Route 32 about a ½ mile southeast from the intersection of NYS Route 32 and NYS Route 300. The property is currently vacant and is 15.14 acres in size located within the IB zoning district. The site plan proposes a one story 1,500 sf an office building for the property to be serviced by onsite well and septic system. It is proposed to have 8 parking spaces as required by code for the office area. It is anticipated that two employees will staff the office during working hours between 7am and 4pm Monday through Saturday.

The applicant proposes to utilize the remainder of the property for the storage and processing of materials for the applicant's current landscape business. The storage and processing of materials at this location will include the following:

- 1. Unfinished Soil material stockpile area that will be screened with an onsite screener to produce topsoil. The topsoil will be stockpiled within a covered containment area.
- 2. Tree stumps, limbs and wooded debris stockpile for processing into mulch. The mulch will then be stockpiled into individual containment areas depending on color.
- 3. Clean fill materials (concrete, brick, rock, etc.) will be stockpiled and then processed through an onsite crusher to make stone. The stone will then be stockpiled within a containment area.
- 4. Millings from the applicant's paving shall be stockpiled on site.

Mr. Ewasutyn

The application proposes to store equipment on the site. The equipment shall consist of tandem dump trucks, backhoe, bobcat, loader, excavators, skid steers, paver and smaller dump trucks as is currently used for the applicant's business. These vehicles will also be used at the site for the above material processing. A list of the equipment and vehicles has been included on the site plan in the form of a note. The site plan also proposes the make, model and location for the screener, wood chipper and crusher.

The site plan has been revised to present a full build out of the property and what may be anticipated for the greatest extent of the proposed use. It is proposed to disturb approximately 12.5 acres of the property for the proposed operations. The stockpile areas have been updated to be the following volumes:

- 1. The raw material stockpiles will vary in size but will be no larger than the following:
 - a. Topsoil 5,000 yds
 - i. Finished product containment area of 1,700 yds
 - b. Stone 10,000 yds

i. Finished product containment area of 1,800 yds

- c. Mulch 10,000 yds.
 - i. Finished product containment area for each color 1,500 yds
- d. Millings 5,800 yds
 (All stockpile areas are a maximum of 8 ft high)

If you require any additional information or have any questions, please do not hesitate to contact our office. Our office looks forward to presenting this application at the next available Planning Board agenda.

Sincerely,

LANC & TULLY, P.C.

John Quenan Kom

John Queenan, P.E.


Enc.

CC: Pat Hines, MH&E Dominic Cordisco, Esq. Ken Wersted.CME – Via Email



OUTDOOR STORAGE NOTES:

- SHALL NOT BE CLOSER THAN 10 FEET TO ANY SIDE OR REAR LOT LINE OR 50 FEET FROM
- . ALL OUTDOOR STORAGE AREAS SHALL BE APPROPRIATELY SCREENED WITH LANDSCAPING SO
- STORED CANNOT EXCEED THE HEIGHT OF THE BARRIER.
- . NO STORAGE AREA SHALL OCCUPY MORE THAN 30% OF THE SIDE OR REAR YARD.

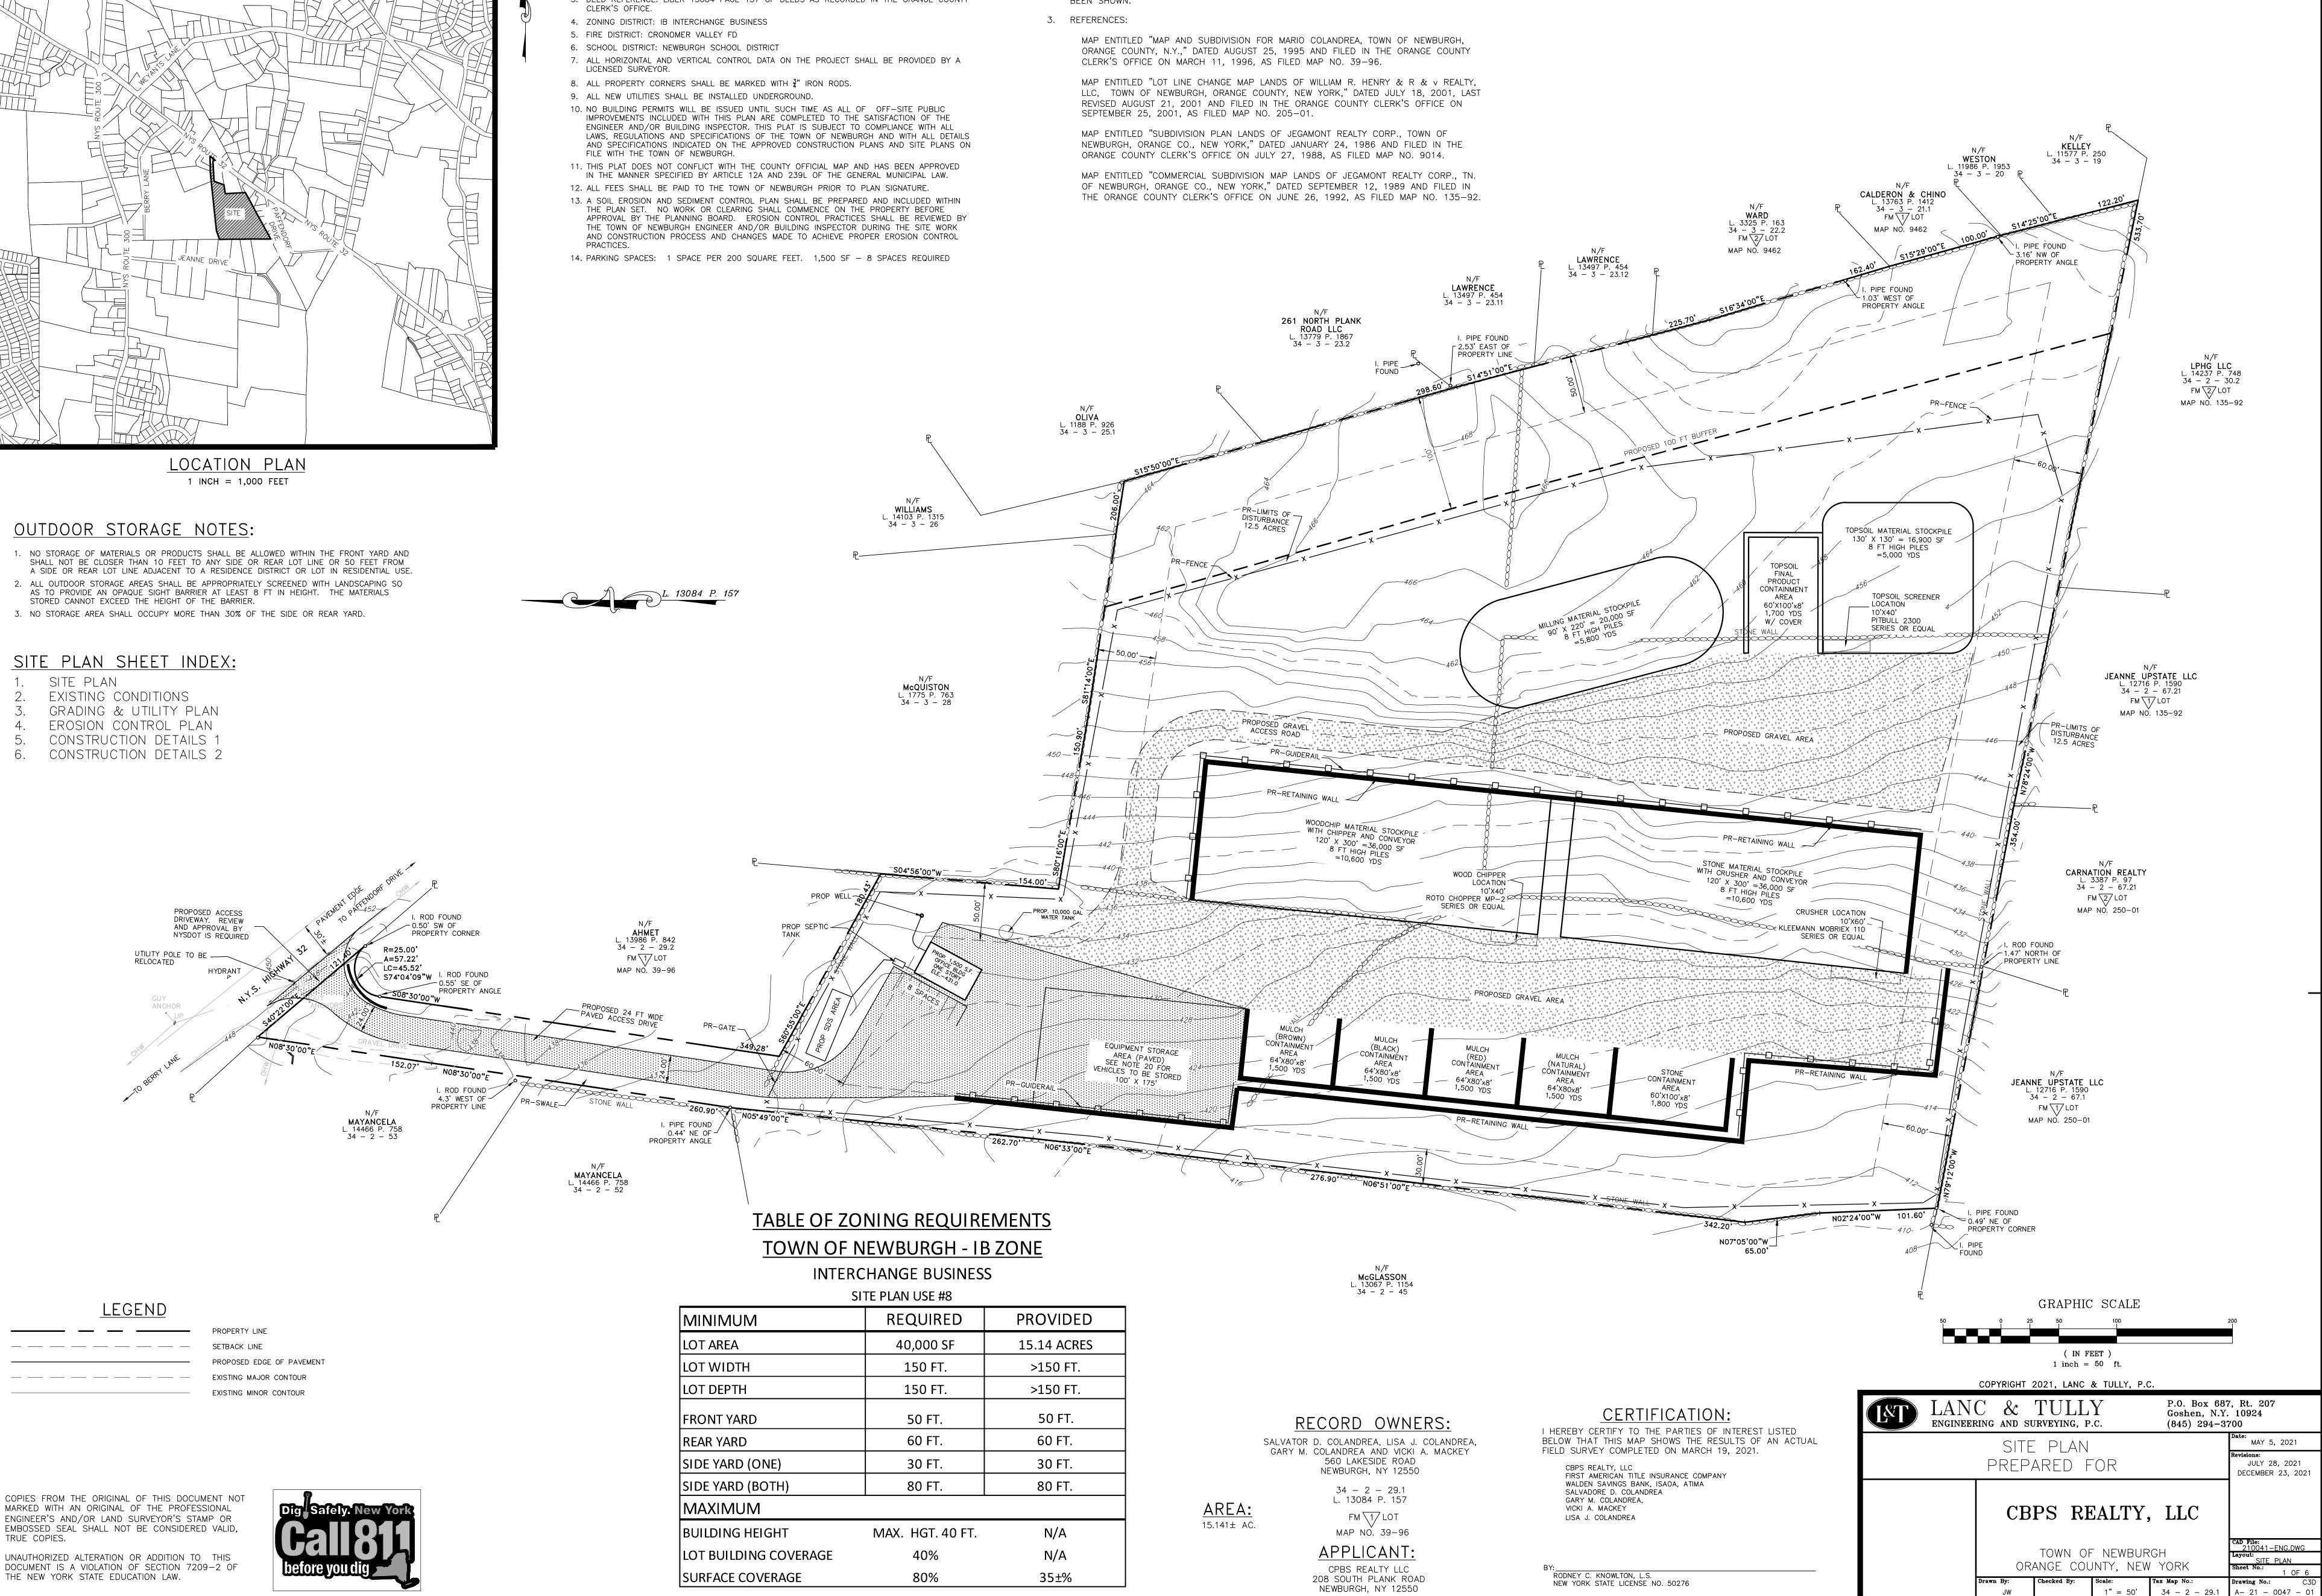



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GENERAL NOTES:

1. TAX MAP DESIGNATION: SECTION 34, BLOCK 2, LOT 29.1

2. TOTAL AREA: 15.14± ACRES 3. DEED REFERENCE: LIBER 13084 PAGE 157 OF DEEDS AS RECORDED IN THE ORANGE COUNTY

SURVEY NOTES:

1. THIS SURVEY IS SUBJECT TO ANY FINDINGS OF A TITLE SEARCH.

2. SUBSURFACE STRUCTURES AND UTILITIES NOT VISIBLE AT THE TIME OF SURVEY HAVE NOT BEEN SHOWN.

SITE PLAN USE #8				
MINIMUM	REQUIRED	PROVIDED		
LOT AREA	40,000 SF	15.14 ACRES		
LOT WIDTH	150 FT.	>150 FT.		
LOT DEPTH	150 FT.	>150 FT.		
FRONT YARD	50 FT.	50 FT.		
REAR YARD	60 FT.	60 FT.		
SIDE YARD (ONE)	30 FT.	30 FT.		
SIDE YARD (BOTH)	80 FT.	80 FT.		
MAXIMUM				
BUILDING HEIGHT	MAX. HGT. 40 FT.	N/A		
LOT BUILDING COVERAGE	40%	N/A		
SURFACE COVERAGE	80%	35±%		




NOTES:

- 1. THIS SURVEY IS SUBJECT TO ANY FINDINGS OF A TITLE SEARCH.
- 2. SUBSURFACE STRUCTURES AND UTILITIES NOT VISIBLE AT THE TIME OF SURVEY HAVE NOT BEEN SHOWN.
- 3. REFERENCES:

MAP ENTITLED "MAP AND SUBDIVISION FOR MARIO COLANDREA, TOWN OF NEWBURGH, ORANGE COUNTY, N.Y.," DATED AUGUST 25, 1995 AND FILED IN THE ORANGE COUNTY

560 LAKESIDE ROAD NEWBURGH, NY 12550

FM 1/LOT MAP NO. 39-96

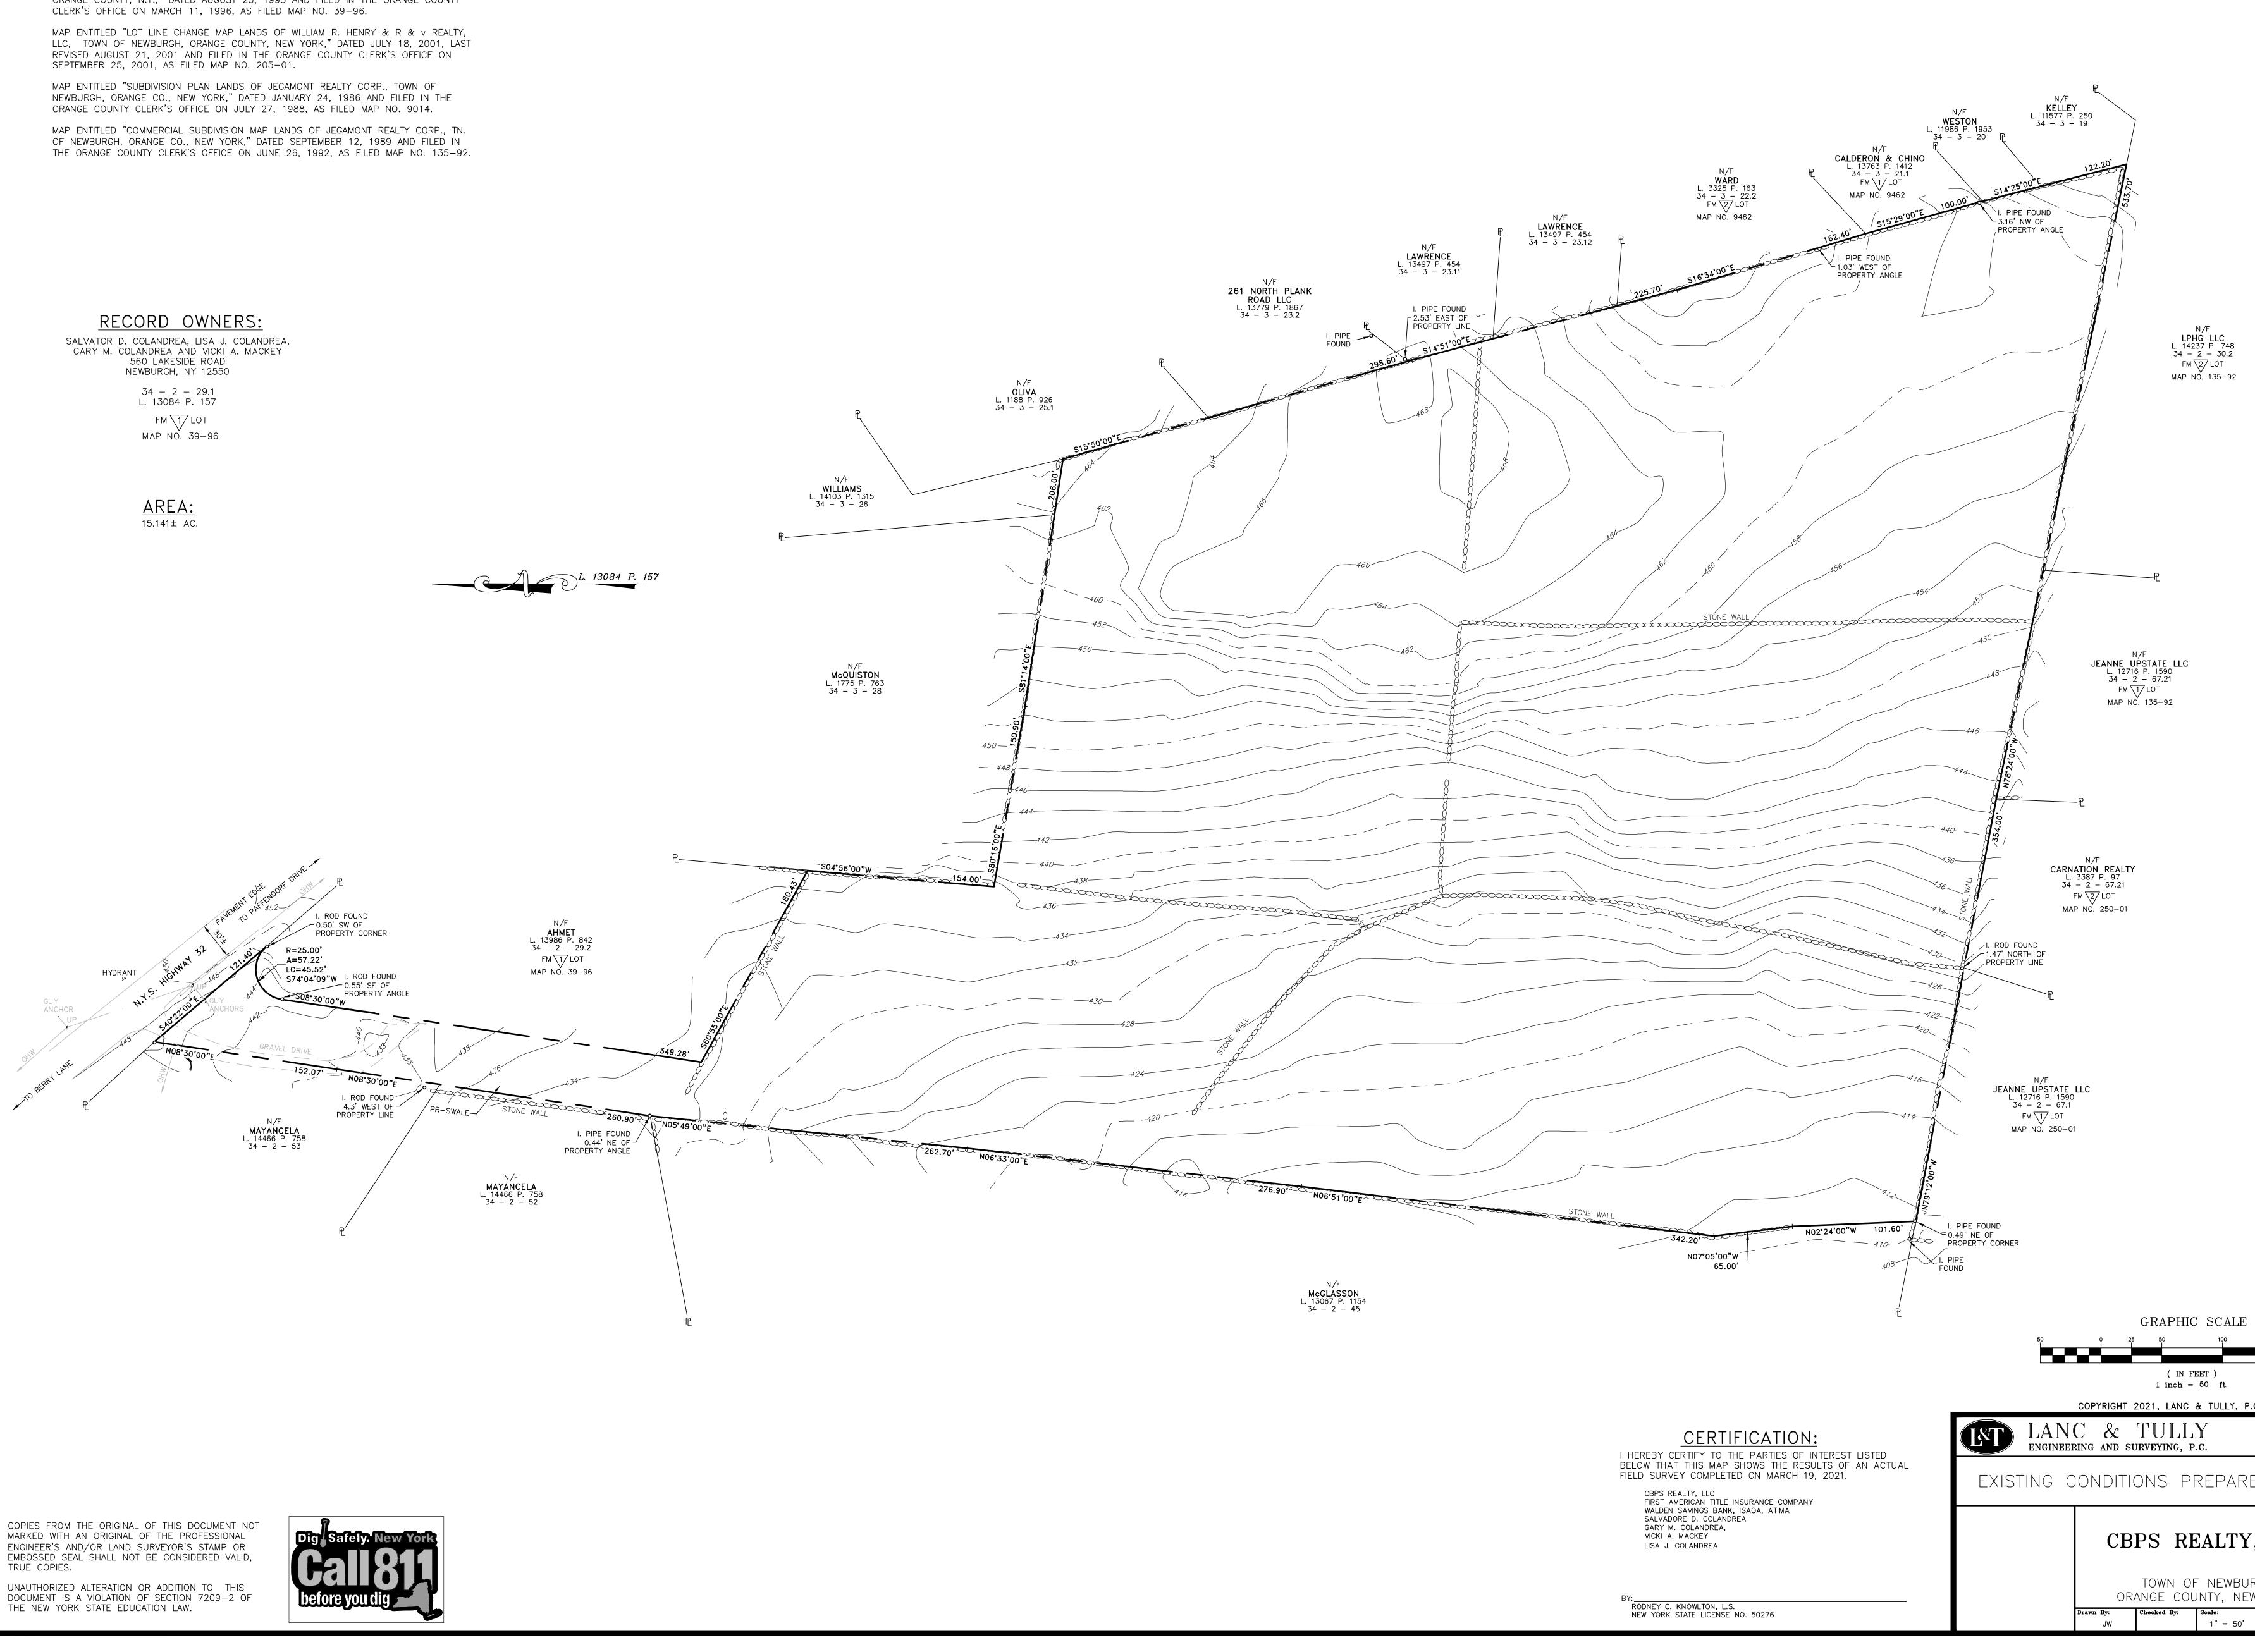


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EET) 50 ft.		_
& TULLY, P.C.		
Y .c.	P.O. Box 68' Goshen, N.Y (845) 294-3	. 10924
		Date: MARCH 24, 2021
REPARED) FOR	Revisions: DECEMBER 23, 2021
EALTY,	LLC	
- NEWBURG	Н	CAD File: 210041-ENG.DWG Layout:
JNTY, NEW		SVY Sheet No.:
	x Map No.:	2 OF 6 Drawing No.: C3D
1" = 50'	- 34 - 2 - 29.1	A- 21 - 0047 - 01

NOTES:

- 1. ALL HORIZONTAL AND VERTICAL CONTROL DATA ON THE PROJECT SHALL BE PROVIDED BY A LICENSED SURVEYOR.
- 2. THE DESIGN AND LOCATION OF SANITARY FACILITIES (WATER AND SEWER SYSTEMS) SHALL ONLY BE CHANGED BY A LICENSED PROFESSIONAL ENGINEER WITH REVIEW AND APPROVAL FROM THE TOWN OF MONROE BUILDING DEPARTMENT.
- 3. A NEW YORK STATE LICENSED PROFESSIONAL ENGINEER (OR OTHER DESIGN PROFESSIONAL AS ALLOWED BY THE NYS EDUCATION DEPARTMENT) SHALL INSPECT THE SANITARY FACILITIES AT THE TIME OF CONSTRUCTION. THE ENGINEER SHALL CERTIFY TO THE LOCAL CODE ENFORCEMENT OFFICER THAT THE FACILITIES HAVE BEEN INSTALLED IN ACCORDANCE WITH THE APPROVED PLANS.
- 4. NO SITE PREPARATION OR CONSTRUCTION SHALL COMMENCE UNTIL ALL REQUIRED PERMITTING AND APPROVALS HAVE BEEN OBTAINED AND THE APPROVED CLEARING LIMIT BOUNDARY HAS BEEN DELINEATED WITH CONSTRUCTION FENCING THROUGHOUT THE SITE.
- 5. MATERIALS, WORKMANSHIP, AND CONSTRUCTION FOR THE SITE IMPROVEMENTS SHOWN HEREON SHALL BE IN ACCORDANCE WITH: NEW YORK STATE DEPARTMENT OF TRANSPORTATION " STANDARD SPECIFICATIONS", 2008; AS SUPPLEMENTED.
- CURRENT PREVAILING MUNICIPAL, COUNTY, AND/OR STATE AGENCY SPECIFICATIONS, STANDARDS, CONDITIONS, AND REQUIREMENTS. CURRENT PREVAILING UTILITY COMPANY/AUTHORITY SPECIFICATIONS, STANDARDS, AND REQUIREMENTS. CURRENT MANUFACTURER SPECIFICATIONS, STANDARDS, AND REQUIREMENTS.
- 6. GAS, LIGHTING, CABLE TELEVISION, AND ELECTRICAL SERVICE PLANS, IF REQUIRED, SHALL BE PREPARED BY THE RESPECTIVE UTILITY COMPANIES THAT SERVICE THE AREA PRIOR
- TO SITE CONSTRUCTION AND SHALL BE INSTALLED PER ORDINANCE REQUIREMENTS. 7. TELEPHONE, ELECTRIC, AND GAS LINES WILL BE INSTALLED UNDERGROUND. CROSSINGS OF PROPOSED PAVEMENTS WILL BE INSTALLED PRIOR TO THE CONSTRUCTION OF PAVEMENT TOP COURSE.
- 8. UTILITY RELOCATIONS SHOWN HEREON, IF ANY, ARE FOR INFORMATIONAL PURPOSES ONLY AND MAY NOT REPRESENT ALL REQUIRED UTILITY RELOCATIONS. THE CONTRACTOR IS
- RESPONSIBLE FOR PERFORMING AND/OR COORDINATING ALL REQUIRED UTILITY RELOCATIONS IN COOPERATION WITH THE RESPECTIVE UTILITY COMPANY/AUTHORITIES. 9. STORM SEWER PIPING SHALL BE HIGH DENSITY POLYETHYLENE PIPE (HDPE) N-12 OR APPROVED EQUAL AS NOTED. PROPER PIPE COVERAGE PER MANUFACTURER'S SPECIFICATIONS SHALL BE MAINTAINED DURING ALL PHASES OF CONSTRUCTION.
- 10. WATERMAIN AND SERVICE PIPING SHALL BE CLASS 52 DUCTILE IRON PIPING.
- 11. TRAFFIC SIGNAGE AND STRIPING SHALL CORRESPOND TO THE MANUAL ON UNIFORM TRAFFIC CONTROL DEVICES (MUTCD, LATEST REVISION).
- 12. THE BUILDING FOOTPRINT DIMENSIONS SHOWN HEREON ARE APPROXIMATE TO WITHIN A ONE FOOT TOLERANCE. FINAL BUILDING FOOTPRINT DIMENSIONS SHALL BE FURNISHED ON THE ARCHITECTURAL PLANS AT THE TIME OF APPLICATION FOR A BUILDING PERMIT. ALL STRUCTURES SHALL CONFORM TO THE APPROVED BULK ZONING REQUIREMENTS AND REQUIREMENTS OF THIS SITE PLAN.
- 13. THIS SET OF PLANS HAS BEEN PREPARED FOR THE PURPOSES OF MUNICIPAL AND AGENCY REVIEW AND APPROVAL. THIS SET OF PLANS SHALL NOT BE UTILIZED AS CONSTRUCTION DOCUMENTS UNTIL ALL APPROVALS REQUIRED FROM RESPECTIVE INVOLVED AGENCIES HAVE BEEN OBTAINED AND ALL CONDITIONS OF APPROVAL HAVE BEEN SATISFIED.
- 14. EXISTING UTILITY INFORMATION SHOWN HEREON HAS BEEN COLLECTED FROM VARIOUS SOURCES AND IS NOT GUARANTEED AS TO ACCURACY OR COMPLETENESS. THE CONTRACTOR SHALL VERIFY ALL INFORMATION TO THEIR SATISFACTION PRIOR TO EXCAVATION. WHERE EXISTING UTILITIES ARE TO BE CROSSED, TEST PITS SHALL BE DUG BY THE CONTRACTOR PRIOR TO CONSTRUCTION TO ASCERTAIN EXISTING INVERTS, MATERIAL, AND SIZES. TEST PIT INFORMATION SHALL BE GIVEN TO THE ENGINEER PRIOR TO CONSTRUCTION TO PERMIT ADJUSTMENTS AS REQUIRED TO AVOID CONFLICTS. THE CONTRACTOR SHALL NOTIFY THE UNDERSIGNED PROFESSIONAL IMMEDIATELY IF ANY FIELD CONDITIONS ENCOUNTERED DIFFER MATERIALLY FROM THOSE REPRESENTED HEREON. SUCH CONDITIONS COULD RENDER THE DESIGNS HEREON INAPPROPRIATE OR INEFFECTIVE.
- 15. THE CONTRACTOR IS RESPONSIBLE FOR PROJECT SAFETY, INCLUDING PROVISION OF ALL APPROPRIATE SAFETY DEVICES AND TRAINING REQUIRED. 16. LANC & TULLY ENGINEERING AND SURVEYING, P.C. WILL REVIEW AND APPROVE OR TAKE OTHER APPROPRIATE ACTION ON THE CONTRACTOR SUBMITTALS, SUCH AS SHOP DRAWINGS, PRODUCT DATA, SAMPLES, AND OTHER DATA, WHICH THE CONTRACTOR IS REQUIRED TO SUBMIT, BUT ONLY FOR THE LIMITED PURPOSE OF CHECKING FOR CONFORMANCE WITH THE DESIGN INTENT AND THE INFORMATION SHOWN IN THE CONSTRUCTION CONTRACT DOCUMENTS, CONSTRUCTION MEANS AND/OR METHODS, COORDINATION OF THE WORK WITH OTHER TRADES, AND CONSTRUCTION SAFETY PRECAUTIONS ARE THE SOLE RESPONSIBILITY OF THE CONTRACTOR. LANC & TULLY ENGINEERING AND SURVEYING, P.C. SHOP DRAWING REVIEW WILL BE CONDUCTED WITH REASONABLE PROMPTNESS WHILE ALLOWING SUFFICIENT TIME TO PERMIT ADEQUATE REVIEW. REVIEW OF A SPECIFIC ITEM SHALL NOT INDICATE THAT LANC & TULLY ENGINEERING AND SURVEYING, P.C. HAS REVIEWED THE ENTIRE ASSEMBLY OF WHICH THE ITEM IS A COMPONENT. LANC & TULLY ENGINEERING AND SURVEYING, P.C. WILL NOT BE RESPONSIBLE FOR ANY DEVIATIONS FROM THE CONSTRUCTION DOCUMENTS NOT BROUGHT TO ITS ATTENTION, IN WRITING, BY THE CONTRACTOR. LANC & TULLY ENGINEERING AND SURVEYING, P.C. WILL NOT BE REQUIRED TO REVIEW PARTIAL SUBMISSIONS OF CORRELATED ITEMS NOT RECEIVED.
- 17. NEITHER THE PROFESSIONAL ACTIVITIES OF LANC & TULLY ENGINEERING AND SURVEYING, P.C., NOR THE PRESENCE OF LANC & TULLY ENGINEERING AND SURVEYING, P.C. OR ITS EMPLOYEES AND SUB-CONSULTANTS AT A CONSTRUCTION/PROJECT SITE, SHALL RELIEVE THE GENERAL CONTRACTOR OF HIS OBLIGATIONS, DUTIES AND RESPONSIBILITIES INCLUDING, BUT NOT LIMITED TO, CONSTRUCTION MEANS, METHODS, SEQUENCE, TECHNIQUES OR PROCEDURES NECESSARY FOR PERFORMING, SUPERINTENDING AND COORDINATING THE WORK IN ACCORDANCE WITH THE CONTRACT DOCUMENTS AND ANY HEALTH AND SAFETY PRECAUTIONS REQUIRED BY ANY REGULATORY AGENCIES. LANC & TULLY ENGINEERING AND SURVEYING, P.C. AND ITS PERSONNEL HAVE NO AUTHORITY TO EXERCISE ANY CONTROL OVER ANY CONSTRUCTION CONTRACTOR OR ITS EMPLOYEES IN CONNECTION WITH THEIR WORK OR ANY HEALTH OR SAFETY PROGRAMS OR PROCEDURES. THE GENERAL CONTRACTOR SHALL BE SOLELY RESPONSIBLE FOR JOB SITE SAFETY. LANC & TULLY ENGINEERING AND SURVEYING, P.C. SHALL BE INDEMNIFIED BY THE GENERAL CONTRACTOR AND SHALL BE NAMED AN ADDITIONAL INSURED UNDER THE GENERAL CONTRACTOR'S POLICIES OF GENERAL LIABILITY INSURANCE.
- 18. IF THE CONTRACTOR DEVIATES FROM THE PLANS AND SPECIFICATIONS, INCLUDING THE NOTES CONTAINED HEREIN, WITHOUT FIRST OBTAINING THE PRIOR WRITTEN AUTHORIZATION OF THE DESIGN ENGINEER AND TOWN BUILDING DEPARTMENT AND/OR TOWN ENGINEER FOR SUCH DEVIATIONS, CONTRACTOR SHALL BE SOLELY RESPONSIBLE FOR THE PAYMENT OF ALL COSTS INCURRED IN CORRECTING ANY WORK DONE WHICH DEVIATES FROM THE PLANS, ALL FINES AND/OR PENAL TIES ASSESSED WITH RESPECT THERETO AND ALL COMPENSATORY OR PUNITIVE DAMAGES RESULTING THEREFROM. THE CONTRACTOR SHALL INDEMNIFY AND HOLD THE OWNER, ENGINEER, AND MUNICIPALITY HARMLESS FROM ALL SUCH COSTS RELATED TO SAME.
- 19. THESE CONSTRUCTION NOTES SHALL APPLY TO ALL SHEETS IN THIS SET. 20. THE FOLLOWING VEHICLES AND EQUIPMENT SHALL BE STORED ON THE SITE:
- A. EXCAVATOR B. BACKHOE
- TANDEM DUMP TRUCK(S) . PAVER TRAILERS
- LOADER G. SKID STEER H. BOBCAT
- HYDROVAC
- J. MINI EXCAVATOR K. MINI DUMP TRUCKS



LEGEND
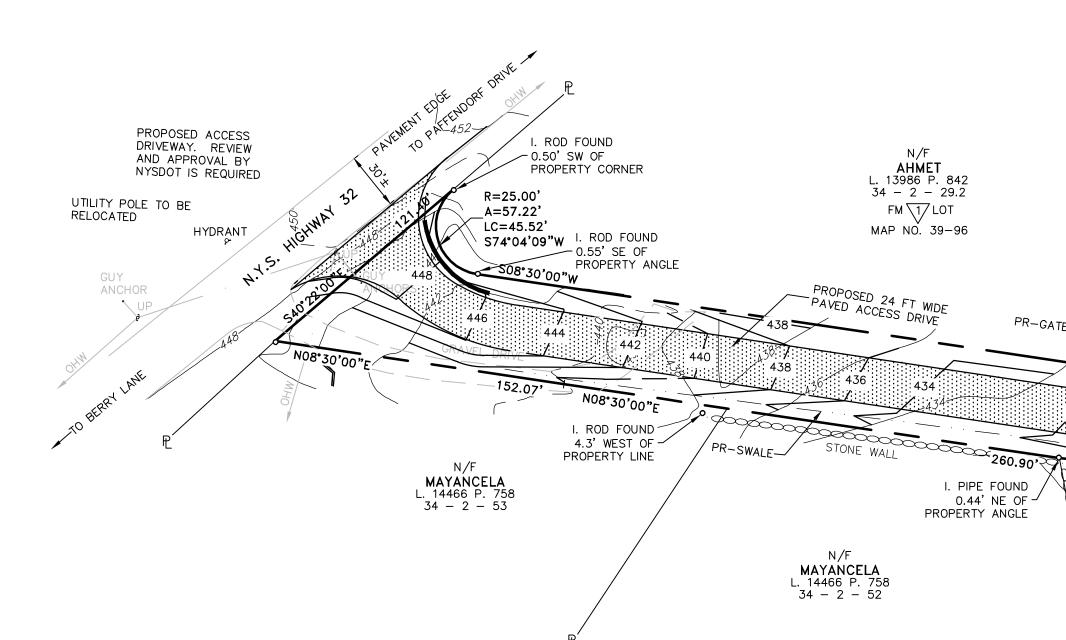
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PROPERTY LINE SETBACK LINE PROPOSED EDGE OF PAVEMENT EXISTING MAJOR CONTOUR EXISTING MINOR CONTOUR PROPOSED MAJOR CONTOUR PROPOSED MINOR CONTOUR PROPOSED GRAVEL AREA

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261 NORTH PLANK **ROAD LLC** L. 13779 P. 1867 34 - 3 - 23.2

N/F

-LIMITS OF -DISTURBANCE 12.5 ACRES PR-FENCE -/ -N/F **McQUISTON** L. 1775 P. 763 34 - 3 - 28 PROPOSED GRAVEL ACCESS ROAD

N/F

OLÍVA L. 1188 P. 926 34 – 3 – 25.1

450 ----R-RETAINING WALL WOODCHIP MATERIAL STOCKPILE WITH CHIPPER AND CONVEYOR 1440 120' X 300' =36,000 SF - 8 FT HIGH PILES =10,600 YDS

PROP. 10,000 GAL WATER TANK

EQUIPMENT STORAGE N

AREA (PAVED) SEE NOTE 20 FOR 4 VEHICLES TO BE STORED

PR-CATCH

BASIN

- x _____ 420 ____

100' X 175'

262.70' NOF' N05°49'00"F

PROP WELL

PROP SEPTIC -

PR-GATF -

N/F

WILLIAMS L. 14103 P. 1315

34 - 3 - 26

<u>-</u>S04°56'00"w_

⇒154.00


N06°33'00

MULCH (BROWN) CONTAINMENT

AREA

64'X80'x8' 1,500 YDS


AREA: 15.141± AC.

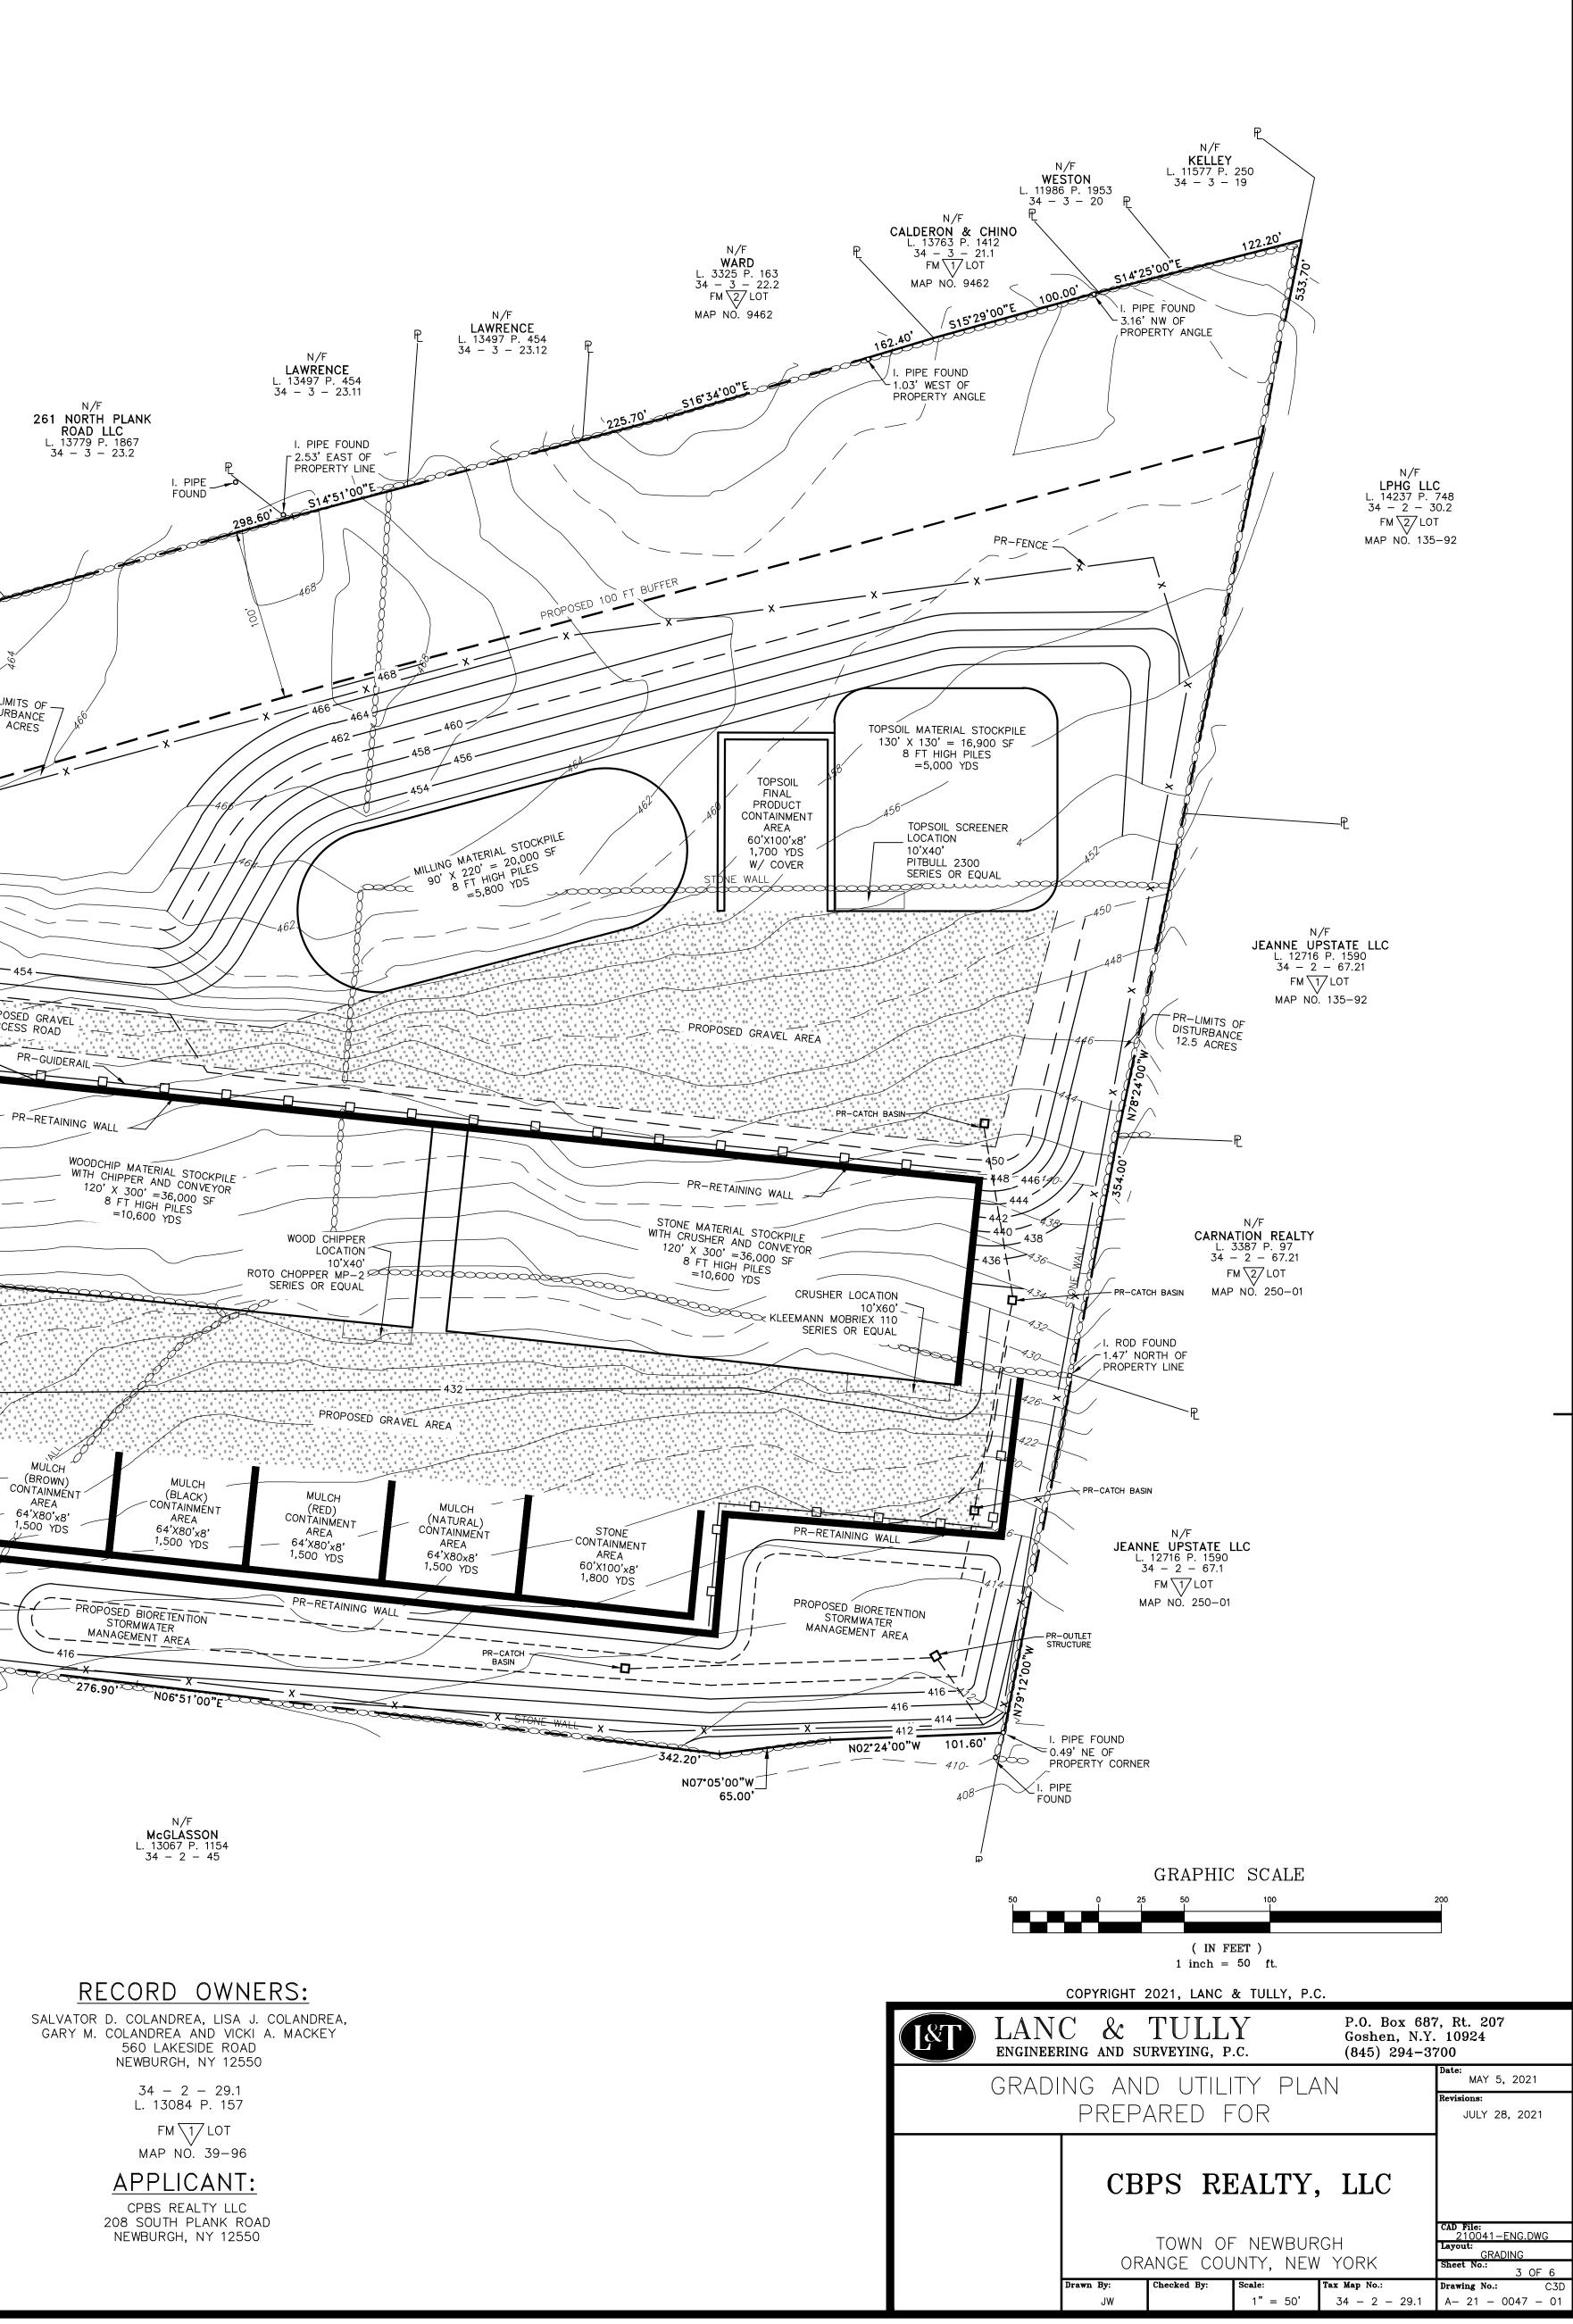



- ALL GRADED OR DISTURBED AREAS INCLUDING SLOPES SHALL BE PROTECTED DURING CLEARING AND CONSTRUCTION IN ACCORDANCE WITH THE APPROVED SEDIMENT CONTROL PLAN UNTIL THEY ARE PERMANENTLY STABILIZED.
- THE APPROVED SEDIMENT CONTROL PLAN AND THE "NEW YORK STATE STANDARDS AND SPECIFICATIONS FOR SOIL EROSION

- WITH LOCAL REQUIREMENTS OR CODES.
- FILLS

- A. LOOSEN SEEDBED BY DISCING TO A 4" DEPTH.

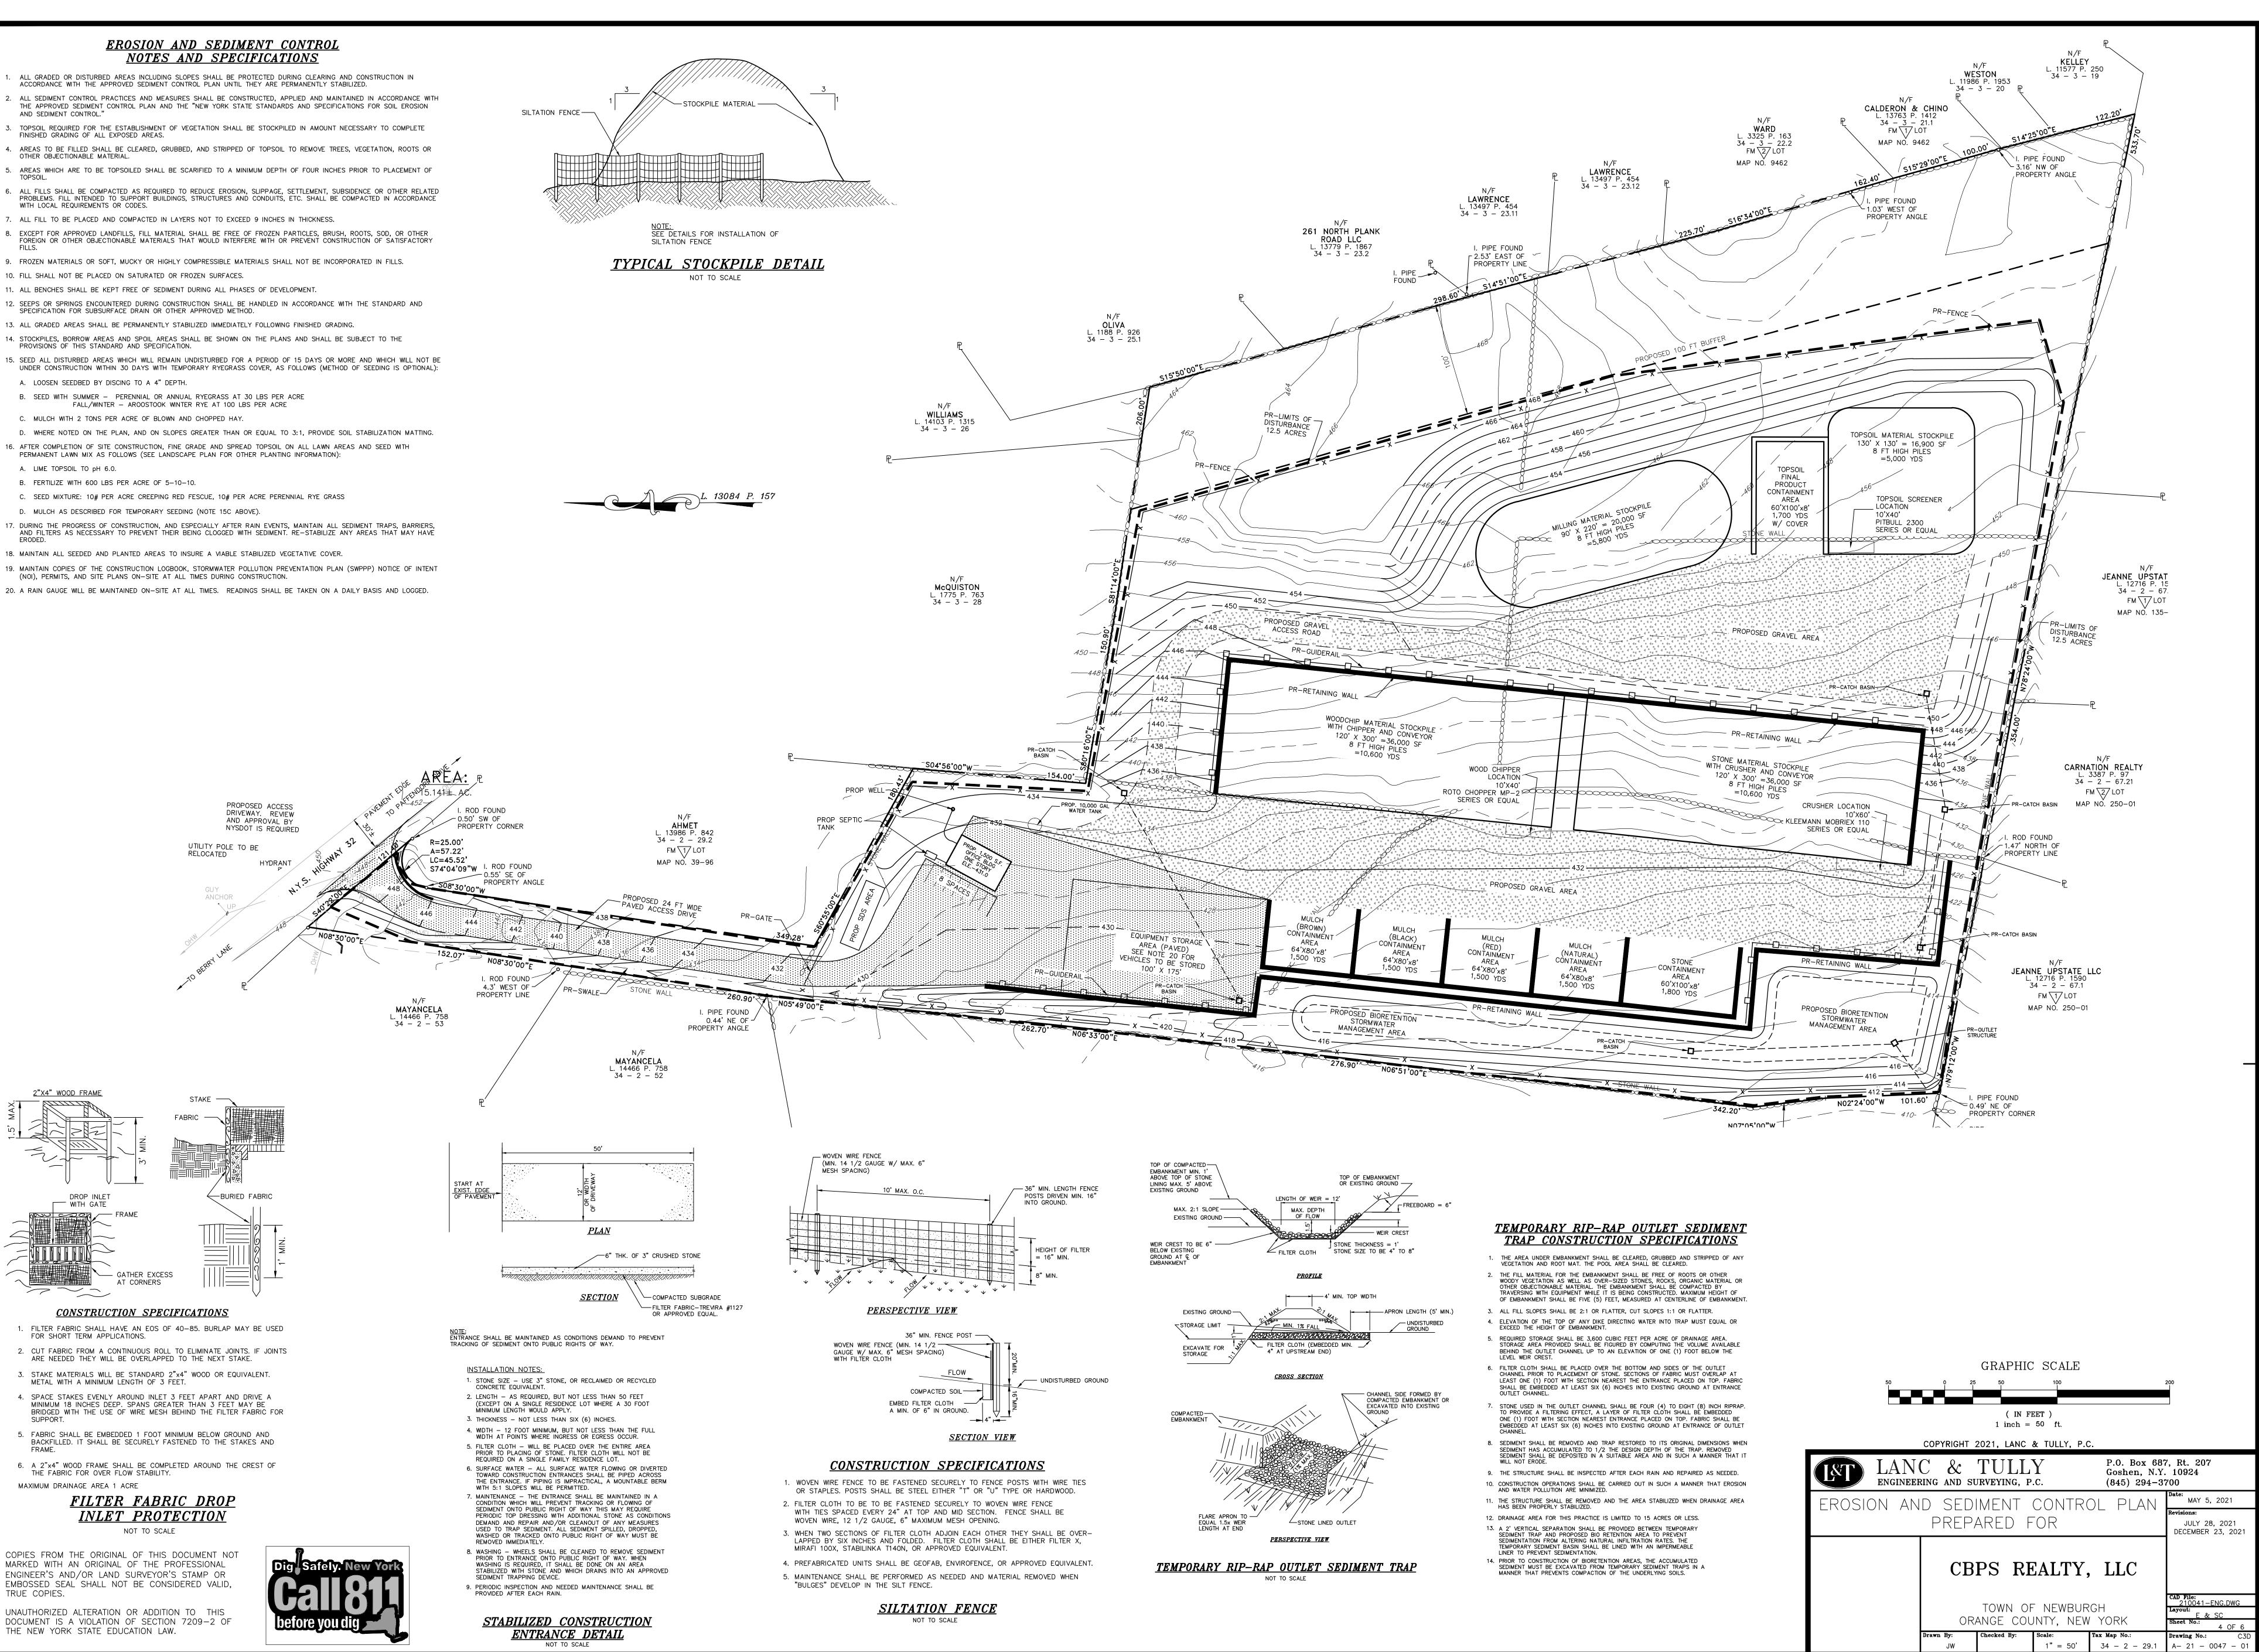

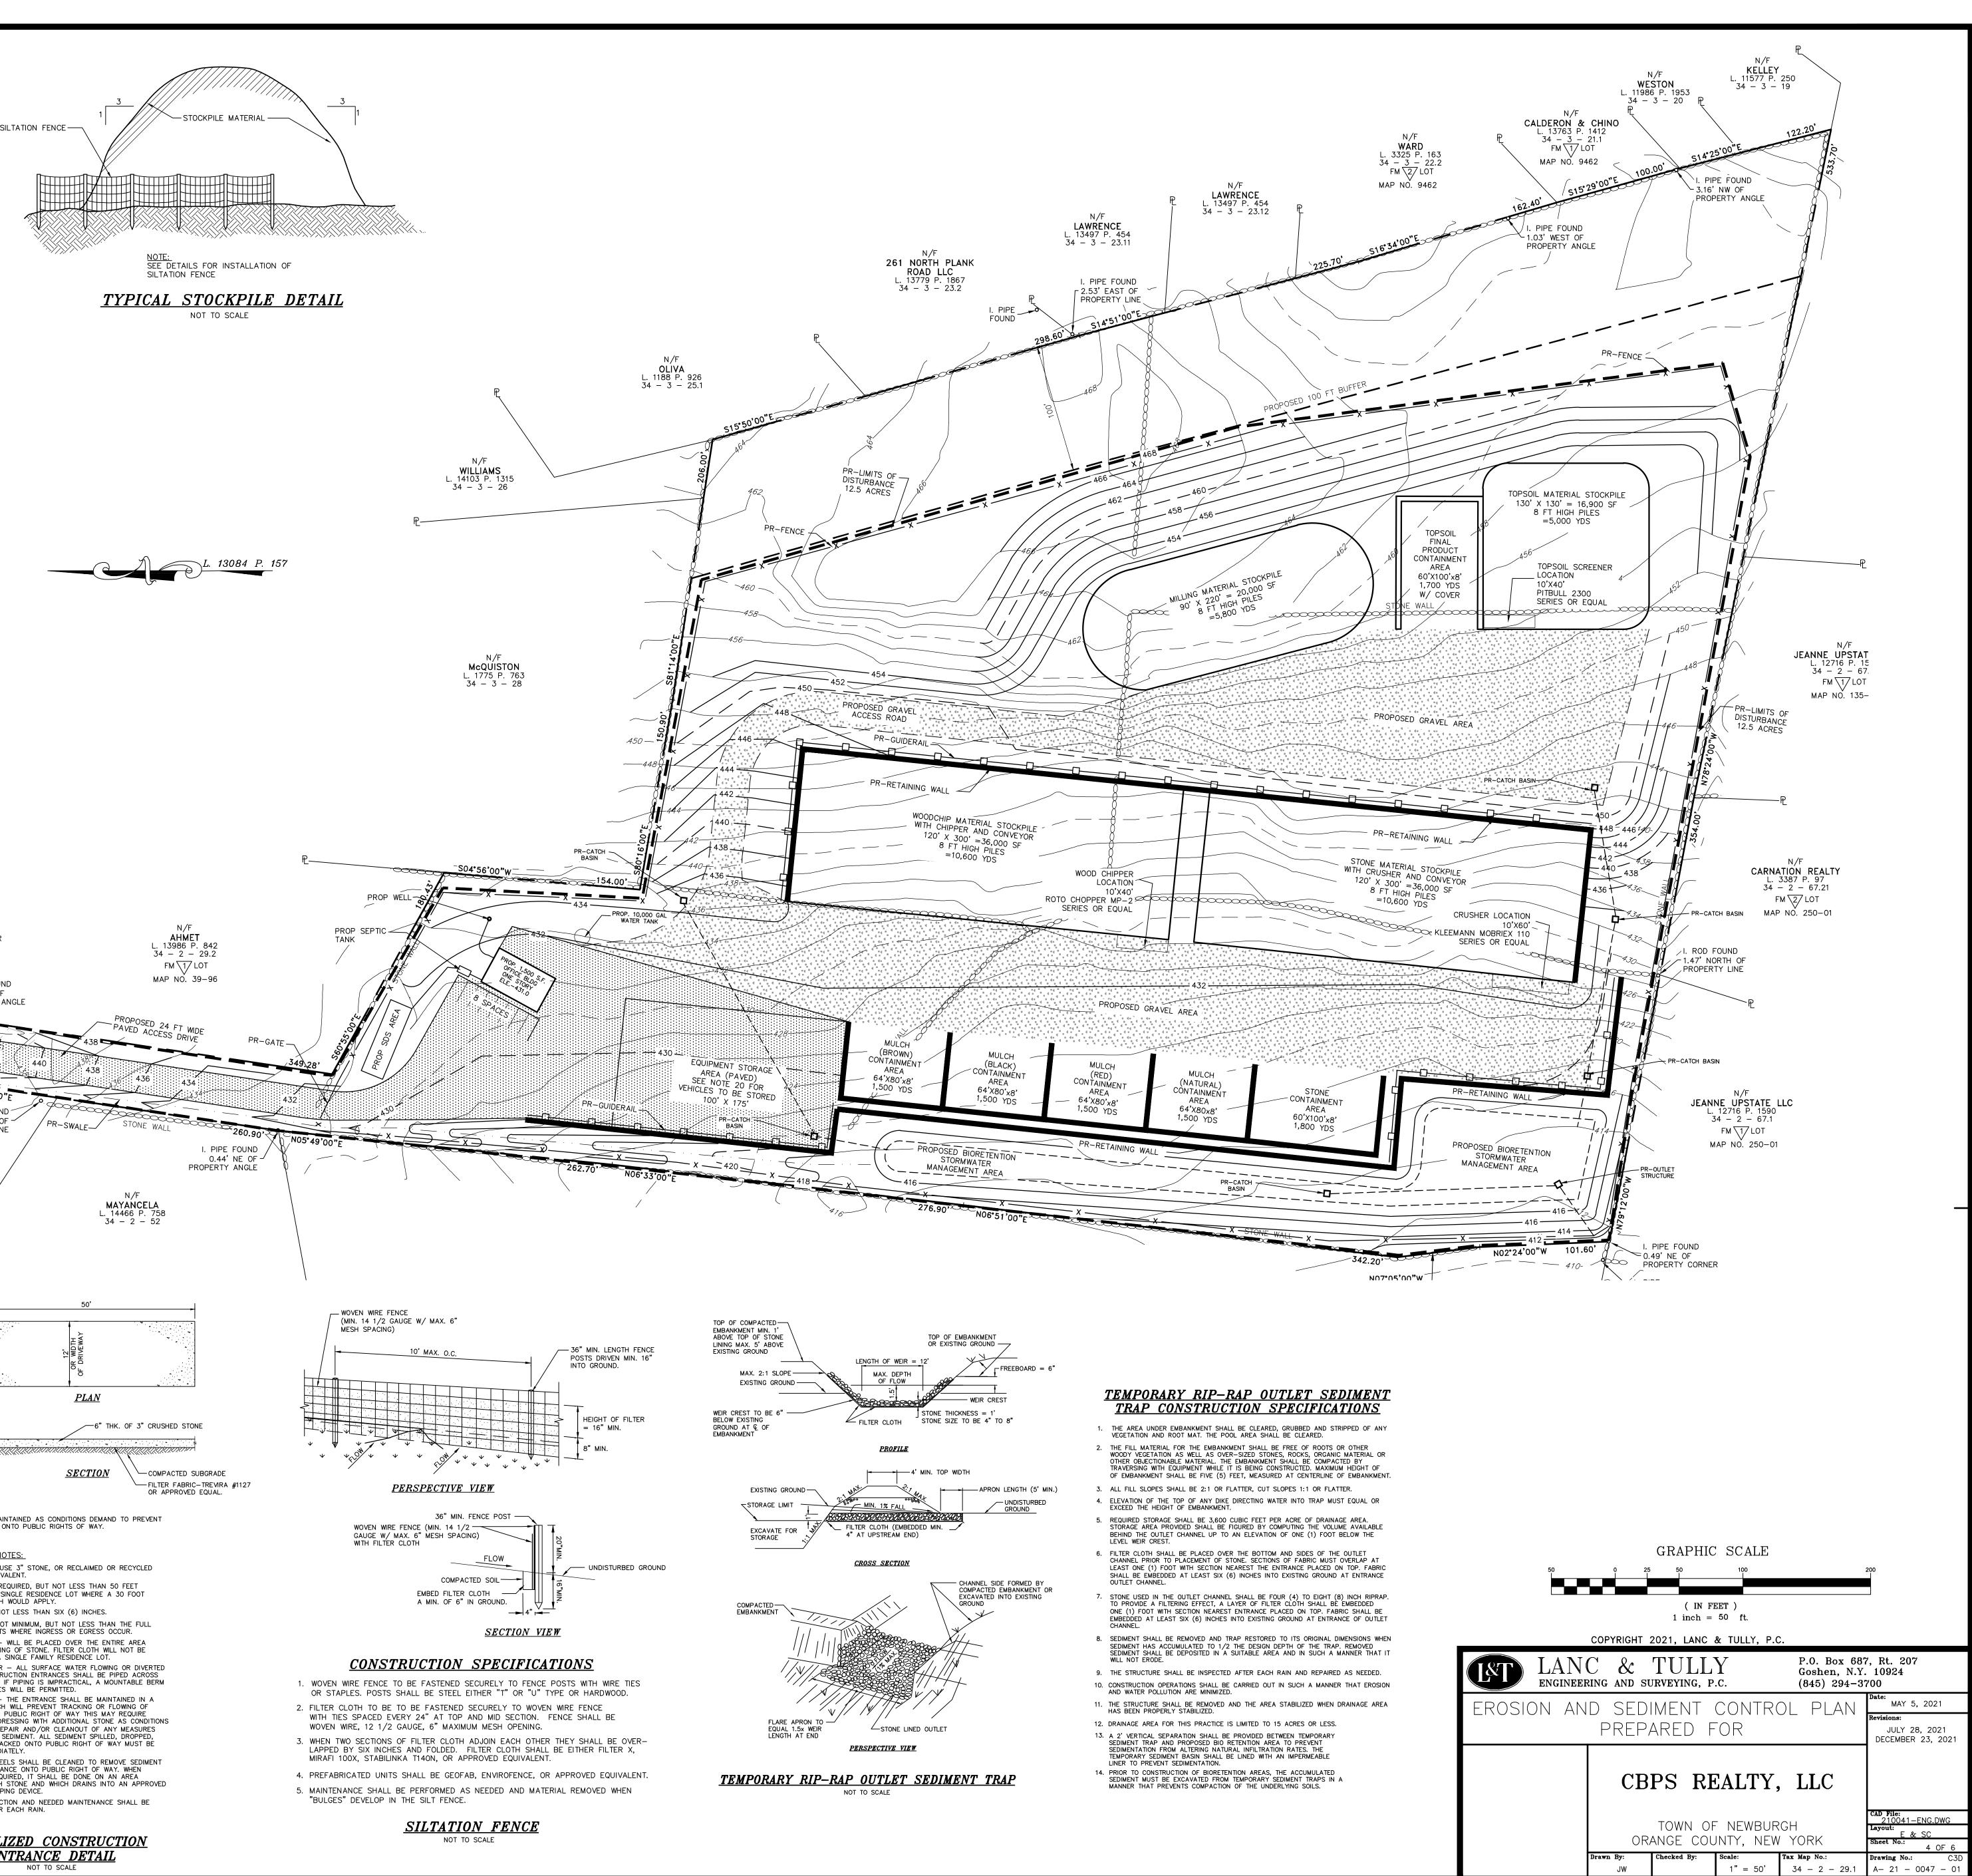

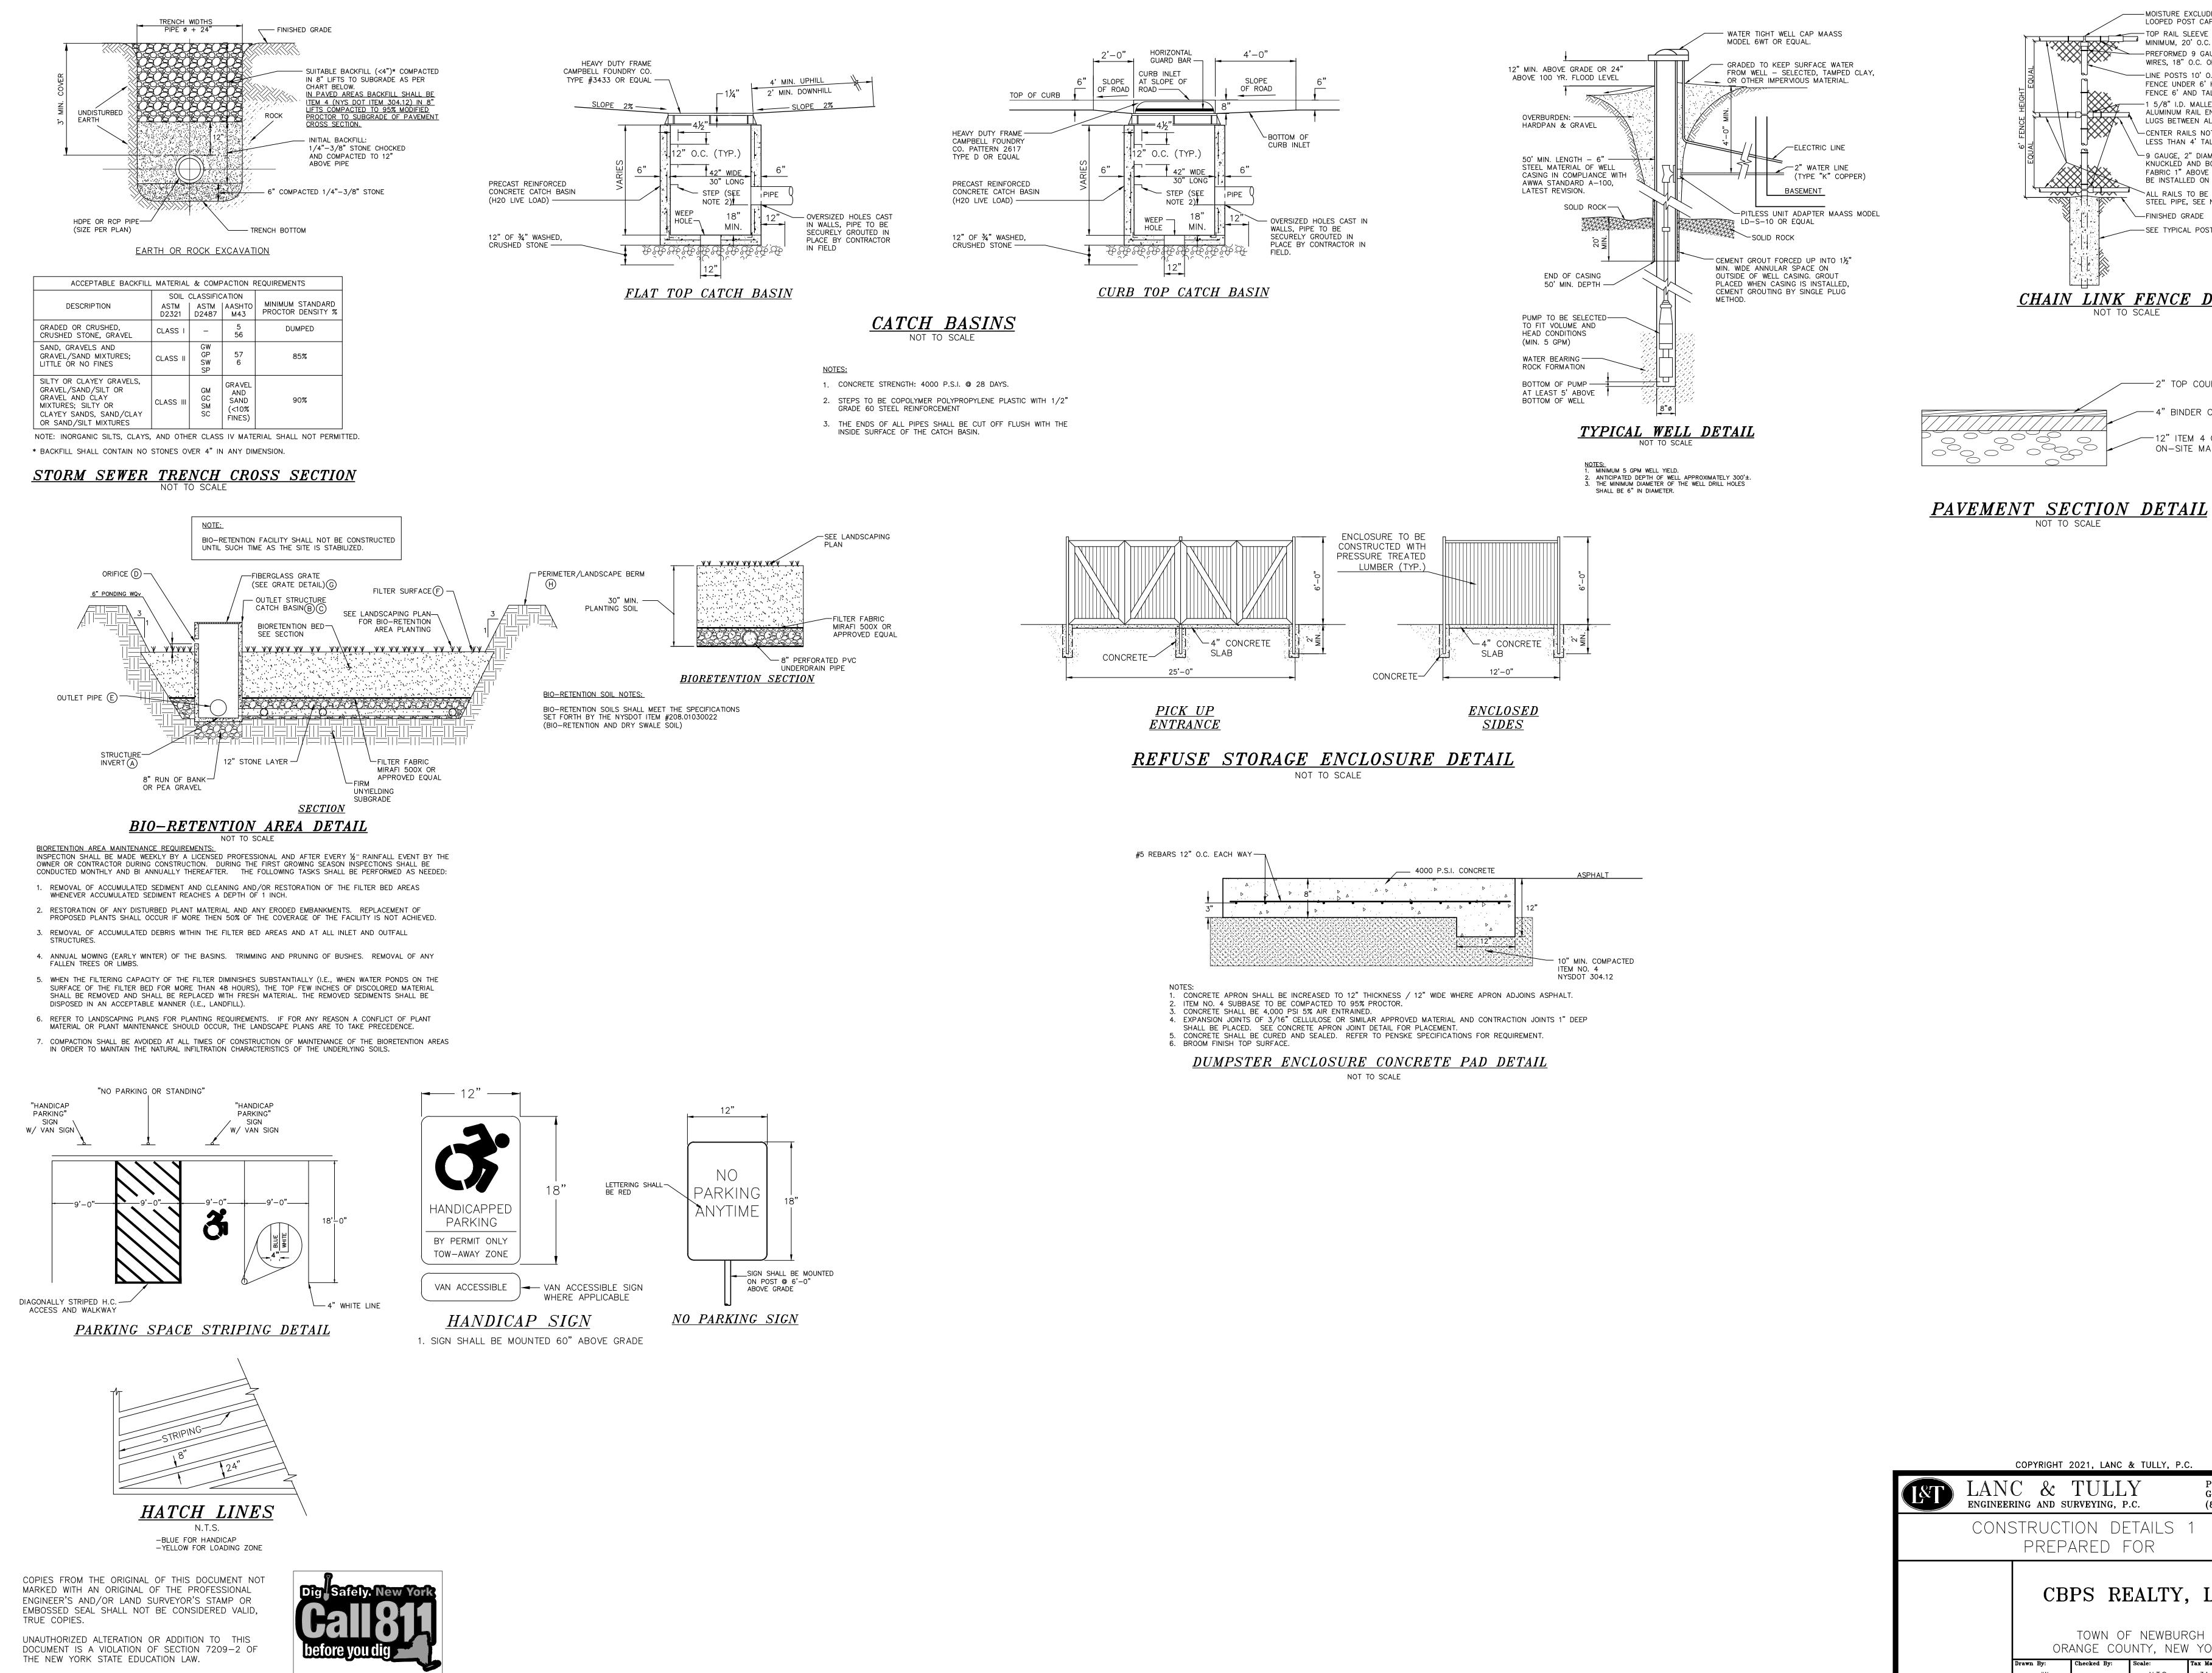

JW

	-MOISTURE EXCLUDING LOOPED POST CAP
	-TOP RAIL SLEEVE 6" LONG MINIMUM, 20' O.C. MAXIMUM
	-PREFORMED 9 GAUGE GALVANIZED STEEL TIE WIRES, 18"O.C. ON RAILS, 12"O.C. ON POSTS
	-LINE POSTS 10' O.C. MAXIMUM 2" O.D. FOR FENCE UNDER 6' HT., 2 1/2" O.D. FOR FENCE 6' AND TALLER
٦ م	-1 5/8" I.D. MALLEABLE IRON OR CAST ALUMINUM RAIL END CUPS WITH OFFSET LUGS BETWEEN ALL POSTS (TYP.)
$\backslash^{}$	-CENTER RAILS NOT REQUIRED ON FENCES LESS THAN 4' TALL
	-9 GAUGE, 2" DIAMOND MESH FABRIC WITH TOP KNUCKLED AND BOTTOM TWISTED. BOTTOM OF FABRIC 1" ABOVE FINISHED GRADE. FABRIC TO BE INSTALLED ON FIELD SIDE.
	ALL RAILS TO BE 1 5/8" O.D. GALVANIZED STEEL PIPE, SEE NOTES BELOW.
	-FINISHED GRADE
	-SEE TYPICAL POST SUPPORT DETAIL

CHAIN LINK FENCE DETAIL

 2" TOP COURSE-TYPE 6F2
 4" BINDER COURSE-TYPE 3
12" ITEM 4 OR OTHER APPROVED ON-SITE MATERIAL

& TULLY, P.C				
Y.c.	Goshen, N.Y.	P.O. Box 687, Rt. 207 Goshen, N.Y. 10924 (845) 294-3700		
TAILS	1	Date: MAY 5, 2021		
FOR	1	Revisions: JULY 28, 2021 DECEMBER 23, 2021		
EALTY,	LLC			
- NEWBUR		CAD File: 210041-ENG.DWG Layout: DETAIL 1		
JNTY, NEW		Sheet No.: 5 OF 6		
Scale: N.T.S.	Tax Map No.: 34 - 2 - 29.1	Drawing No.: C3D A- 21 - 0047 - 01		

REQUIRED SEPARATION DISTANCES FROM WASTEWATER SYSTEM COMPONENTS

SYSTEM COMPONENTS	WELL (f) OR <u>SUCTION LINE</u>	TO STREAM, LAKE WATER COURSE(b), <u>OR WETLAND</u>	DWELLING	PROPERTY <u>LINE</u>	DRAINAGE <u>DITCH(b)(g)</u>
HOUSE SEWER (WATERTIGHT JOINTS)	25' IF CAST IRON OR PVC WITH O-RING JOINTS, 50' OTHERWISE	25'	3'	10'	_
SEPTIC TANK	50'	50'	10'	10'	10'
EFFLUENT LINE TO DISTRIBUTION BOX	50'	50'	10'	10'	10'
DISTRIBUTION BOX	100'	100'	20'	10'	35'
ABSORPTION FIELD	100'(a)	100'	20'	10'	50'
SEEPAGE PIT	150'(a)	100'	20'	10'	50'
DRY WELL (ROOF AND FOOTING)	50'	25'	20'	10'	50'
RAISED OR MOUND SYSTE	EM (c) 100'(a)	100'	20'	10'	50'
INTERMITTENT SAND FILTER (c)	100'(a)	100'	20'	10'	50'
EVAPOTRANSPIRATION ABSORPTION SYSTEM (c)	100'(a)	50'	20'	10'	50'
COMPOSTER	50'	50'	20'	10'	10'
SANITARY PRIVY PIT	100'	50'	20'	10'	35'
PRIVY, WATERTIGHT VAUL	.T 50'	50'	20'	10'	10'

a. WHEN SEWAGE TREATMENT SYSTEMS ARE LOCATED IN COARSE GRAVEL OR UPGRADE AND IN THE GENERAL PATH OF DRAINAGE TO A WELL, THE CLOSEST PART OF THE TREATMENT SYSTEM SHALL BE AT LEAST 200 FEET AWAY FROM THE WELL.

b. MEAN HIGH WATER MARK


c. FOR ALL SYSTEMS INVOLVING THE PLACEMENT OF FILL MATERIAL, SEPARATION DISTANCES ARE MEASURED FROM THE TOE OF SLOPE OF THE FILL.

d. ANY WATER SERVICE LINE UNDER PRESSURE (I.E., PUBLIC WATER SUPPLY MAIN, HOUSEHOLD SERVICE LINE, WELL TO HOUSEHOLD SERVICE LINE) LOCATED WITHIN TEN FEET OF ANY ABSORPTION FIELD, SEEPAGE PIT OR SANITARY PRIVY SHALL BE INSTALLED INSIDE A LARGER DIAMETER WATER MAIN TO PROTECT THE POTABLE WATER SYSTEM.


e. ANY WATER SERVICE LINE UNDER PRESSURE (I.E., PUBLIC WATER SUPPLY MAIN, HOUSEHOLD SERVICE LINE, WELL TO HOUSEHOLD SERVICE LINE) CROSSING A SEWER SHALL BE INSTALLED WITH ONE FULL LENGTH OF WATER MAIN CENTERED ABOVE THE SEWER SO BOTH WATER CONNECTING JOINTS ARE AS FAR AS POSSIBLE FROM THE SEWER. SECTION 8.6 OF THE GLUMRB RECOMMENDED STANDARDS FOR WATER WORKS, SHALL BE FOLLOWED FOR SEPARATION OF THE WATER MAINS, SANITARY SEWERS AND STORM SEWERS.

f. THE MINIMUM SEPARATION DISTANCE BETWEEN A SEPTIC TANK AND A COMMUNITY TYPE PUBLIC WATER SUPPLY WELL SHOULD BE 100 FEET. DISTRIBUTION BOXES AND ABSORPTION FACILITIES (E.G., ABSORPTION TRENCHES/BEDS, SEEPAGE PITS, RAISED SYSTEMS, MOUND SYSTEMS, ETC.) SHOULD BE LOCATED AT LEAST 200 FEET FROM COMMUNITY TYPE PUBLIC WATER SUPPLY WELLS.

RECOMMENDED SEPARATION DISTANCES.

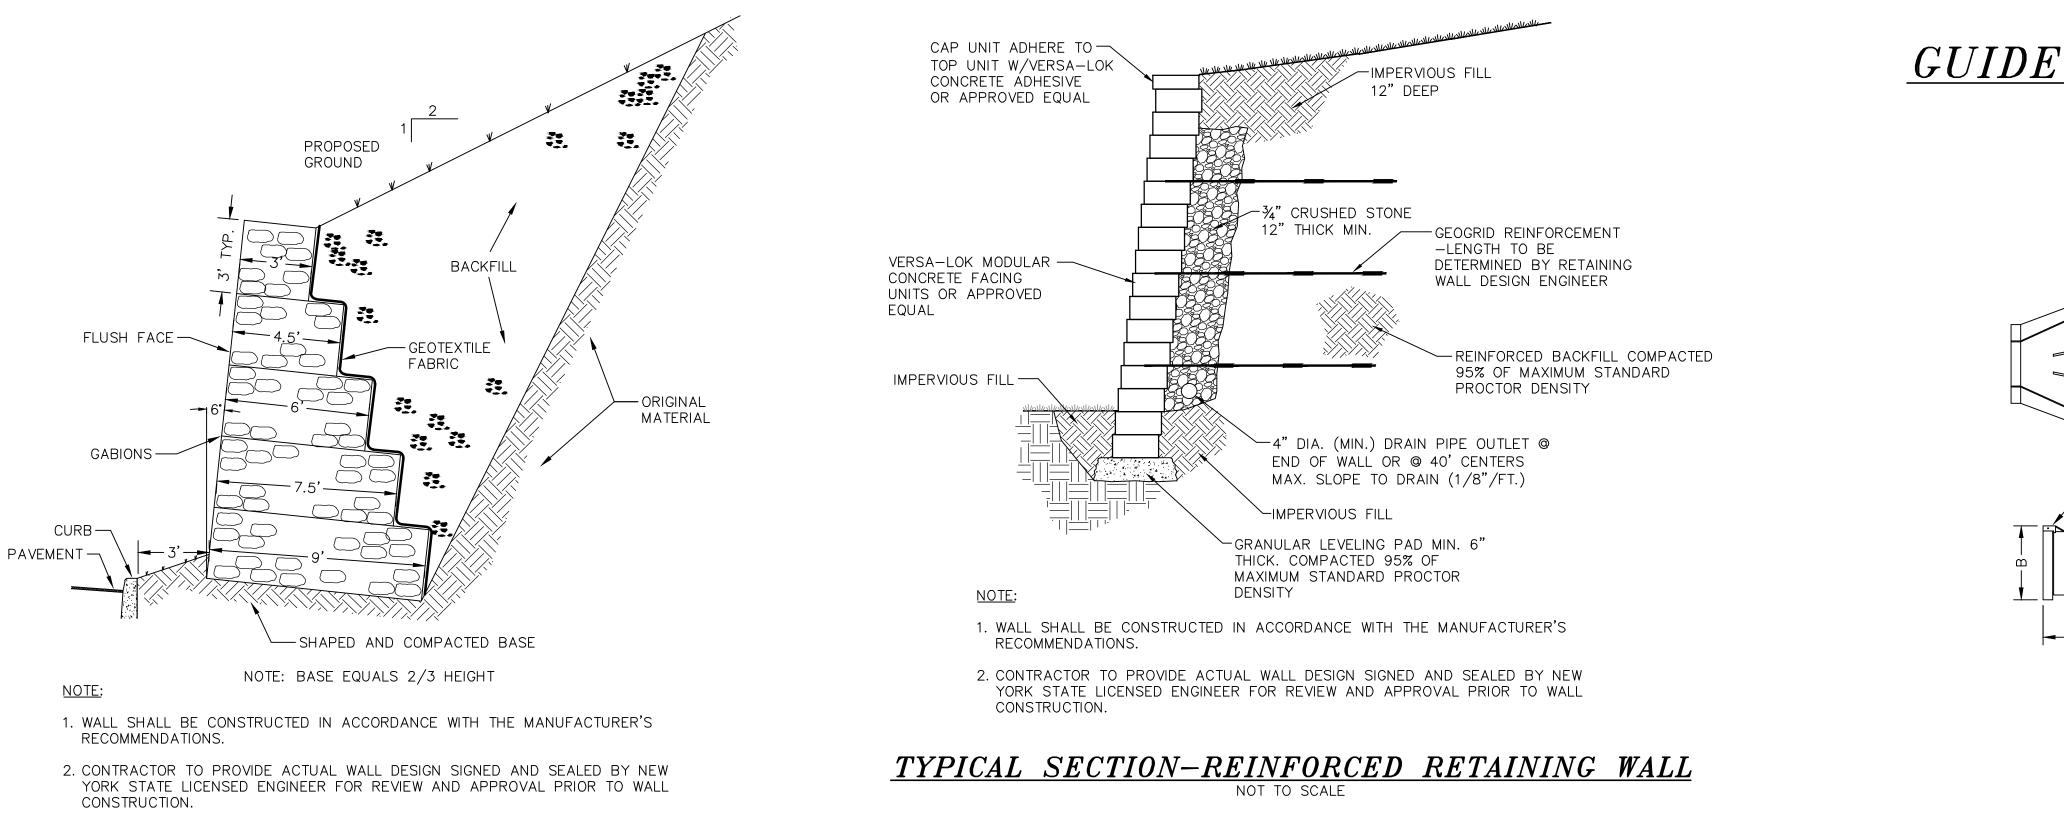



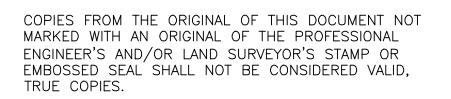



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USE PVC TEE FOR INLET BAFFLE TO MEET NYSDOH REQUIREMENT FOR 16" BELOW LIQUID LEVEL. - 4" SCH. 80 PVC PIPE FROM HOUSE MIN. SLOPE ¼" PER FT.

- 3" MIN. OF SAND OR PEA GRAVEL

DEFLECTOR

gð.

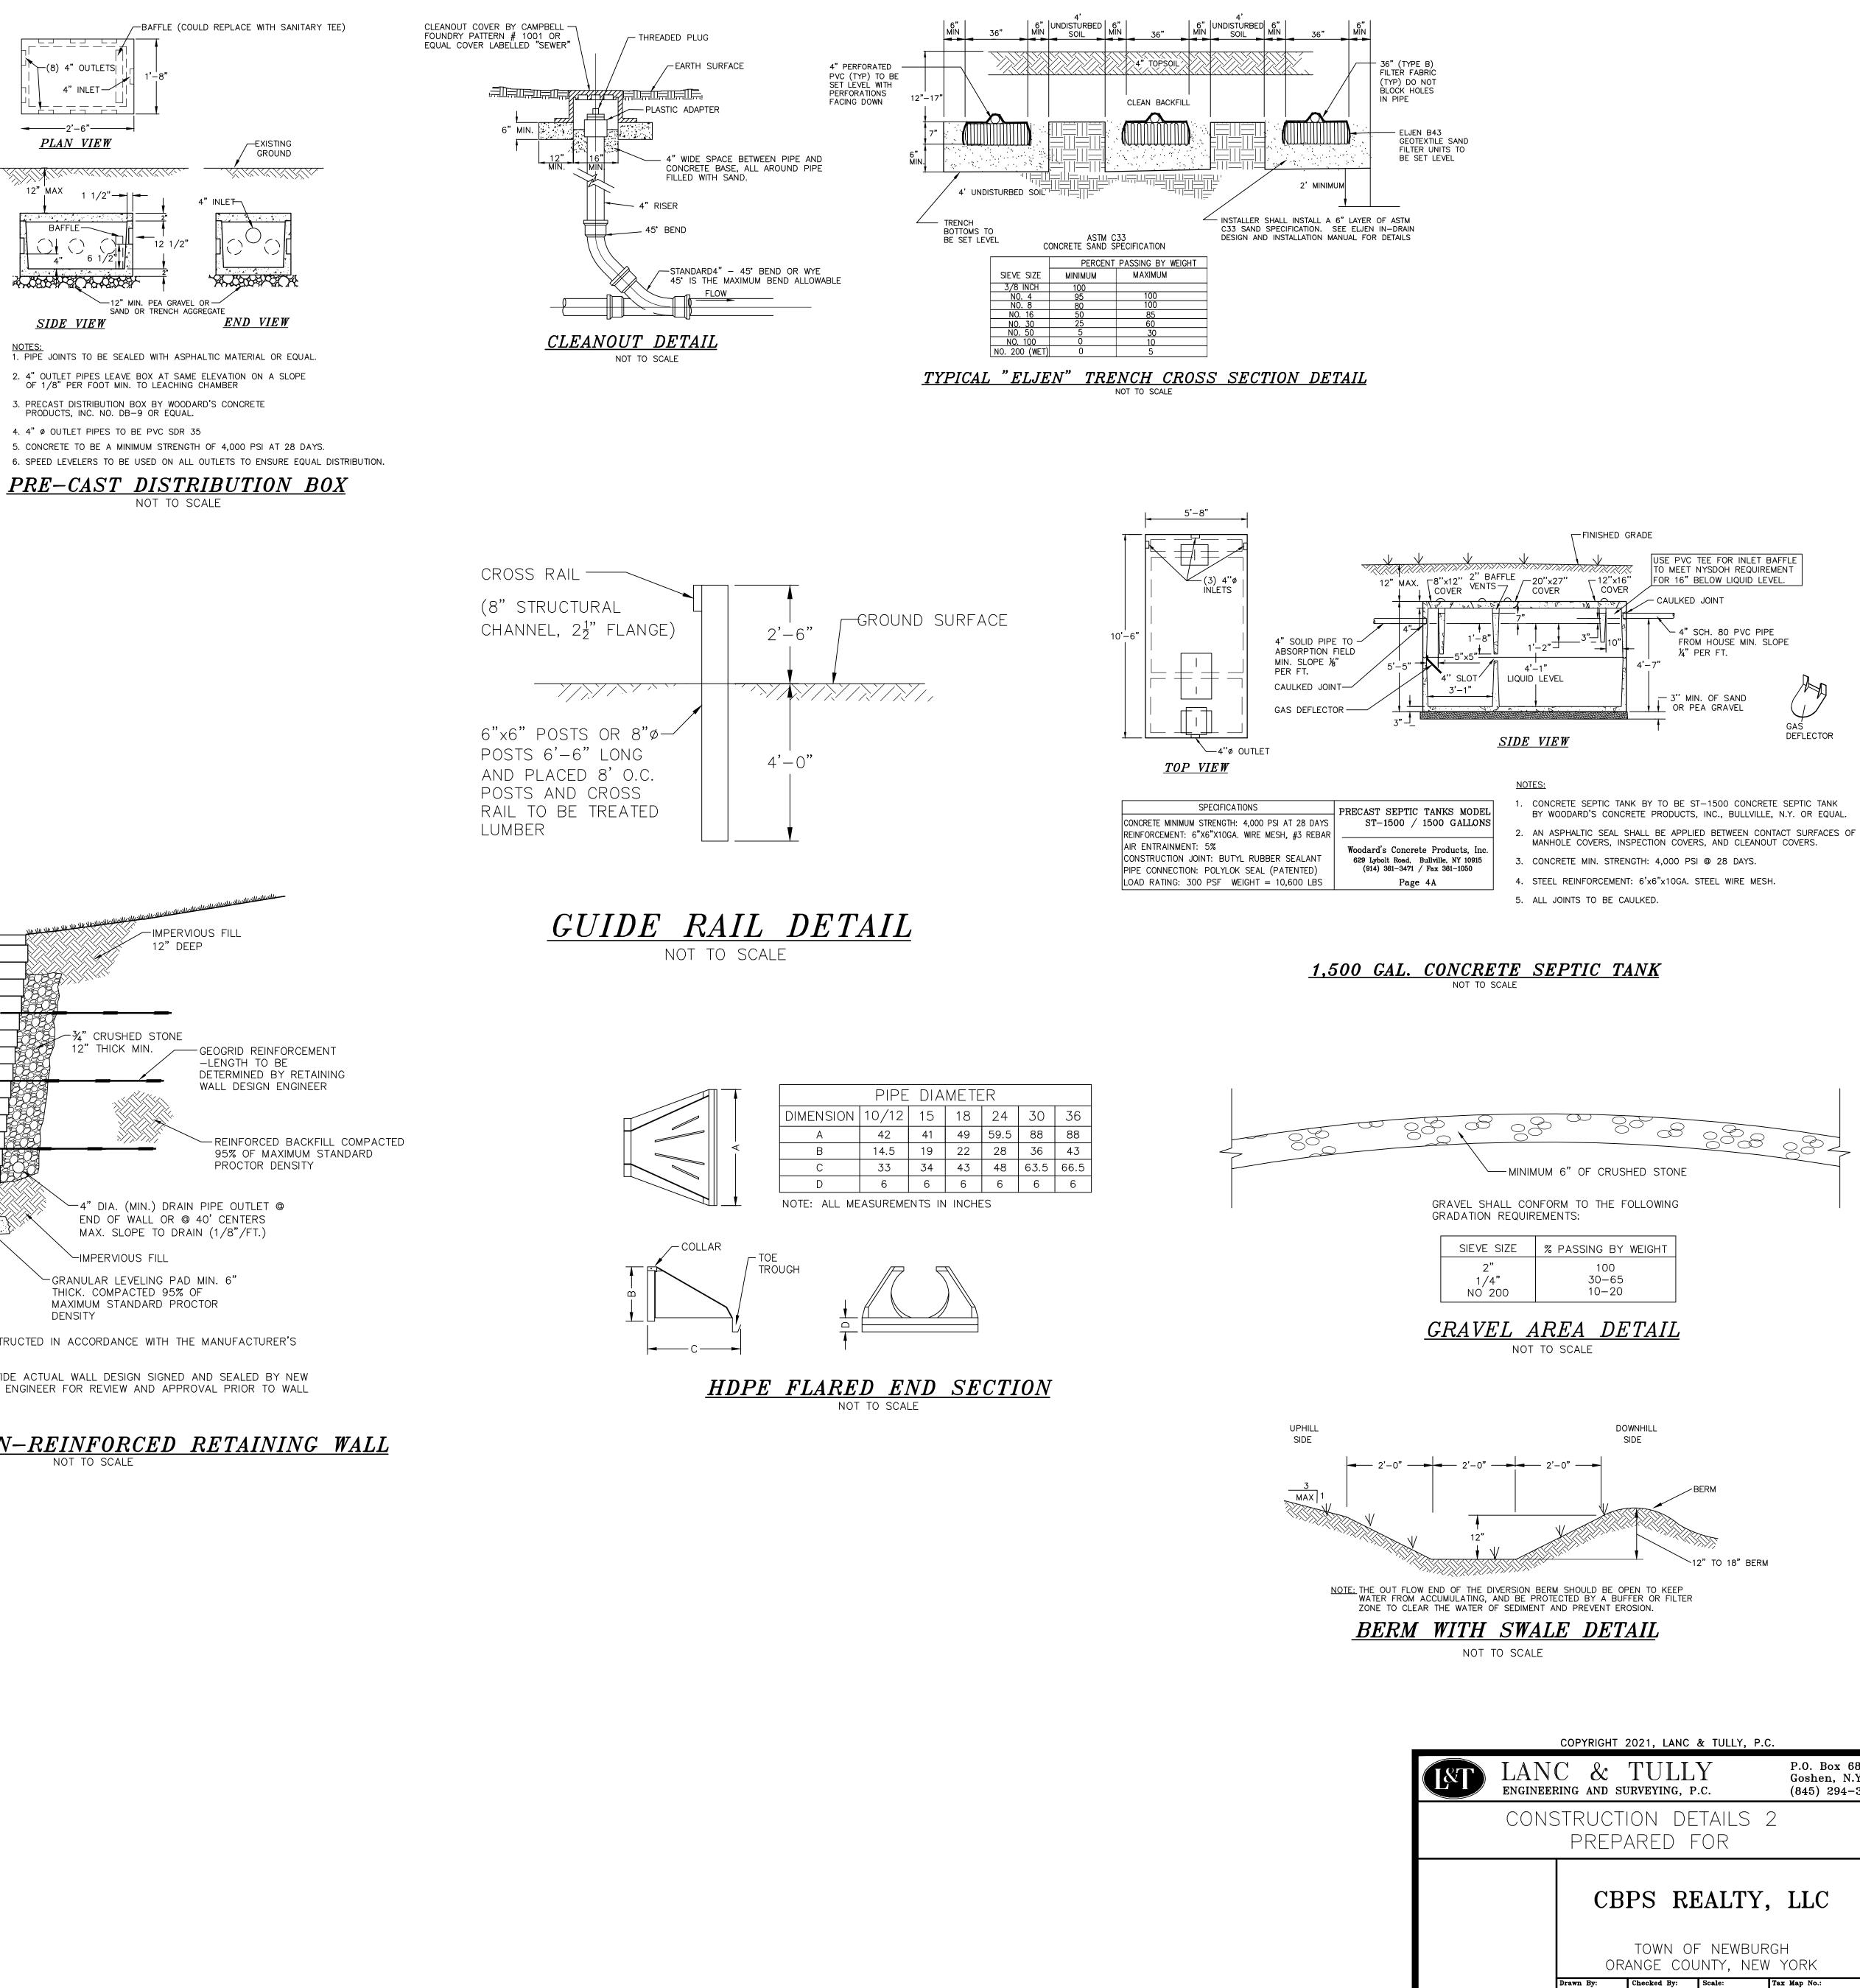JW

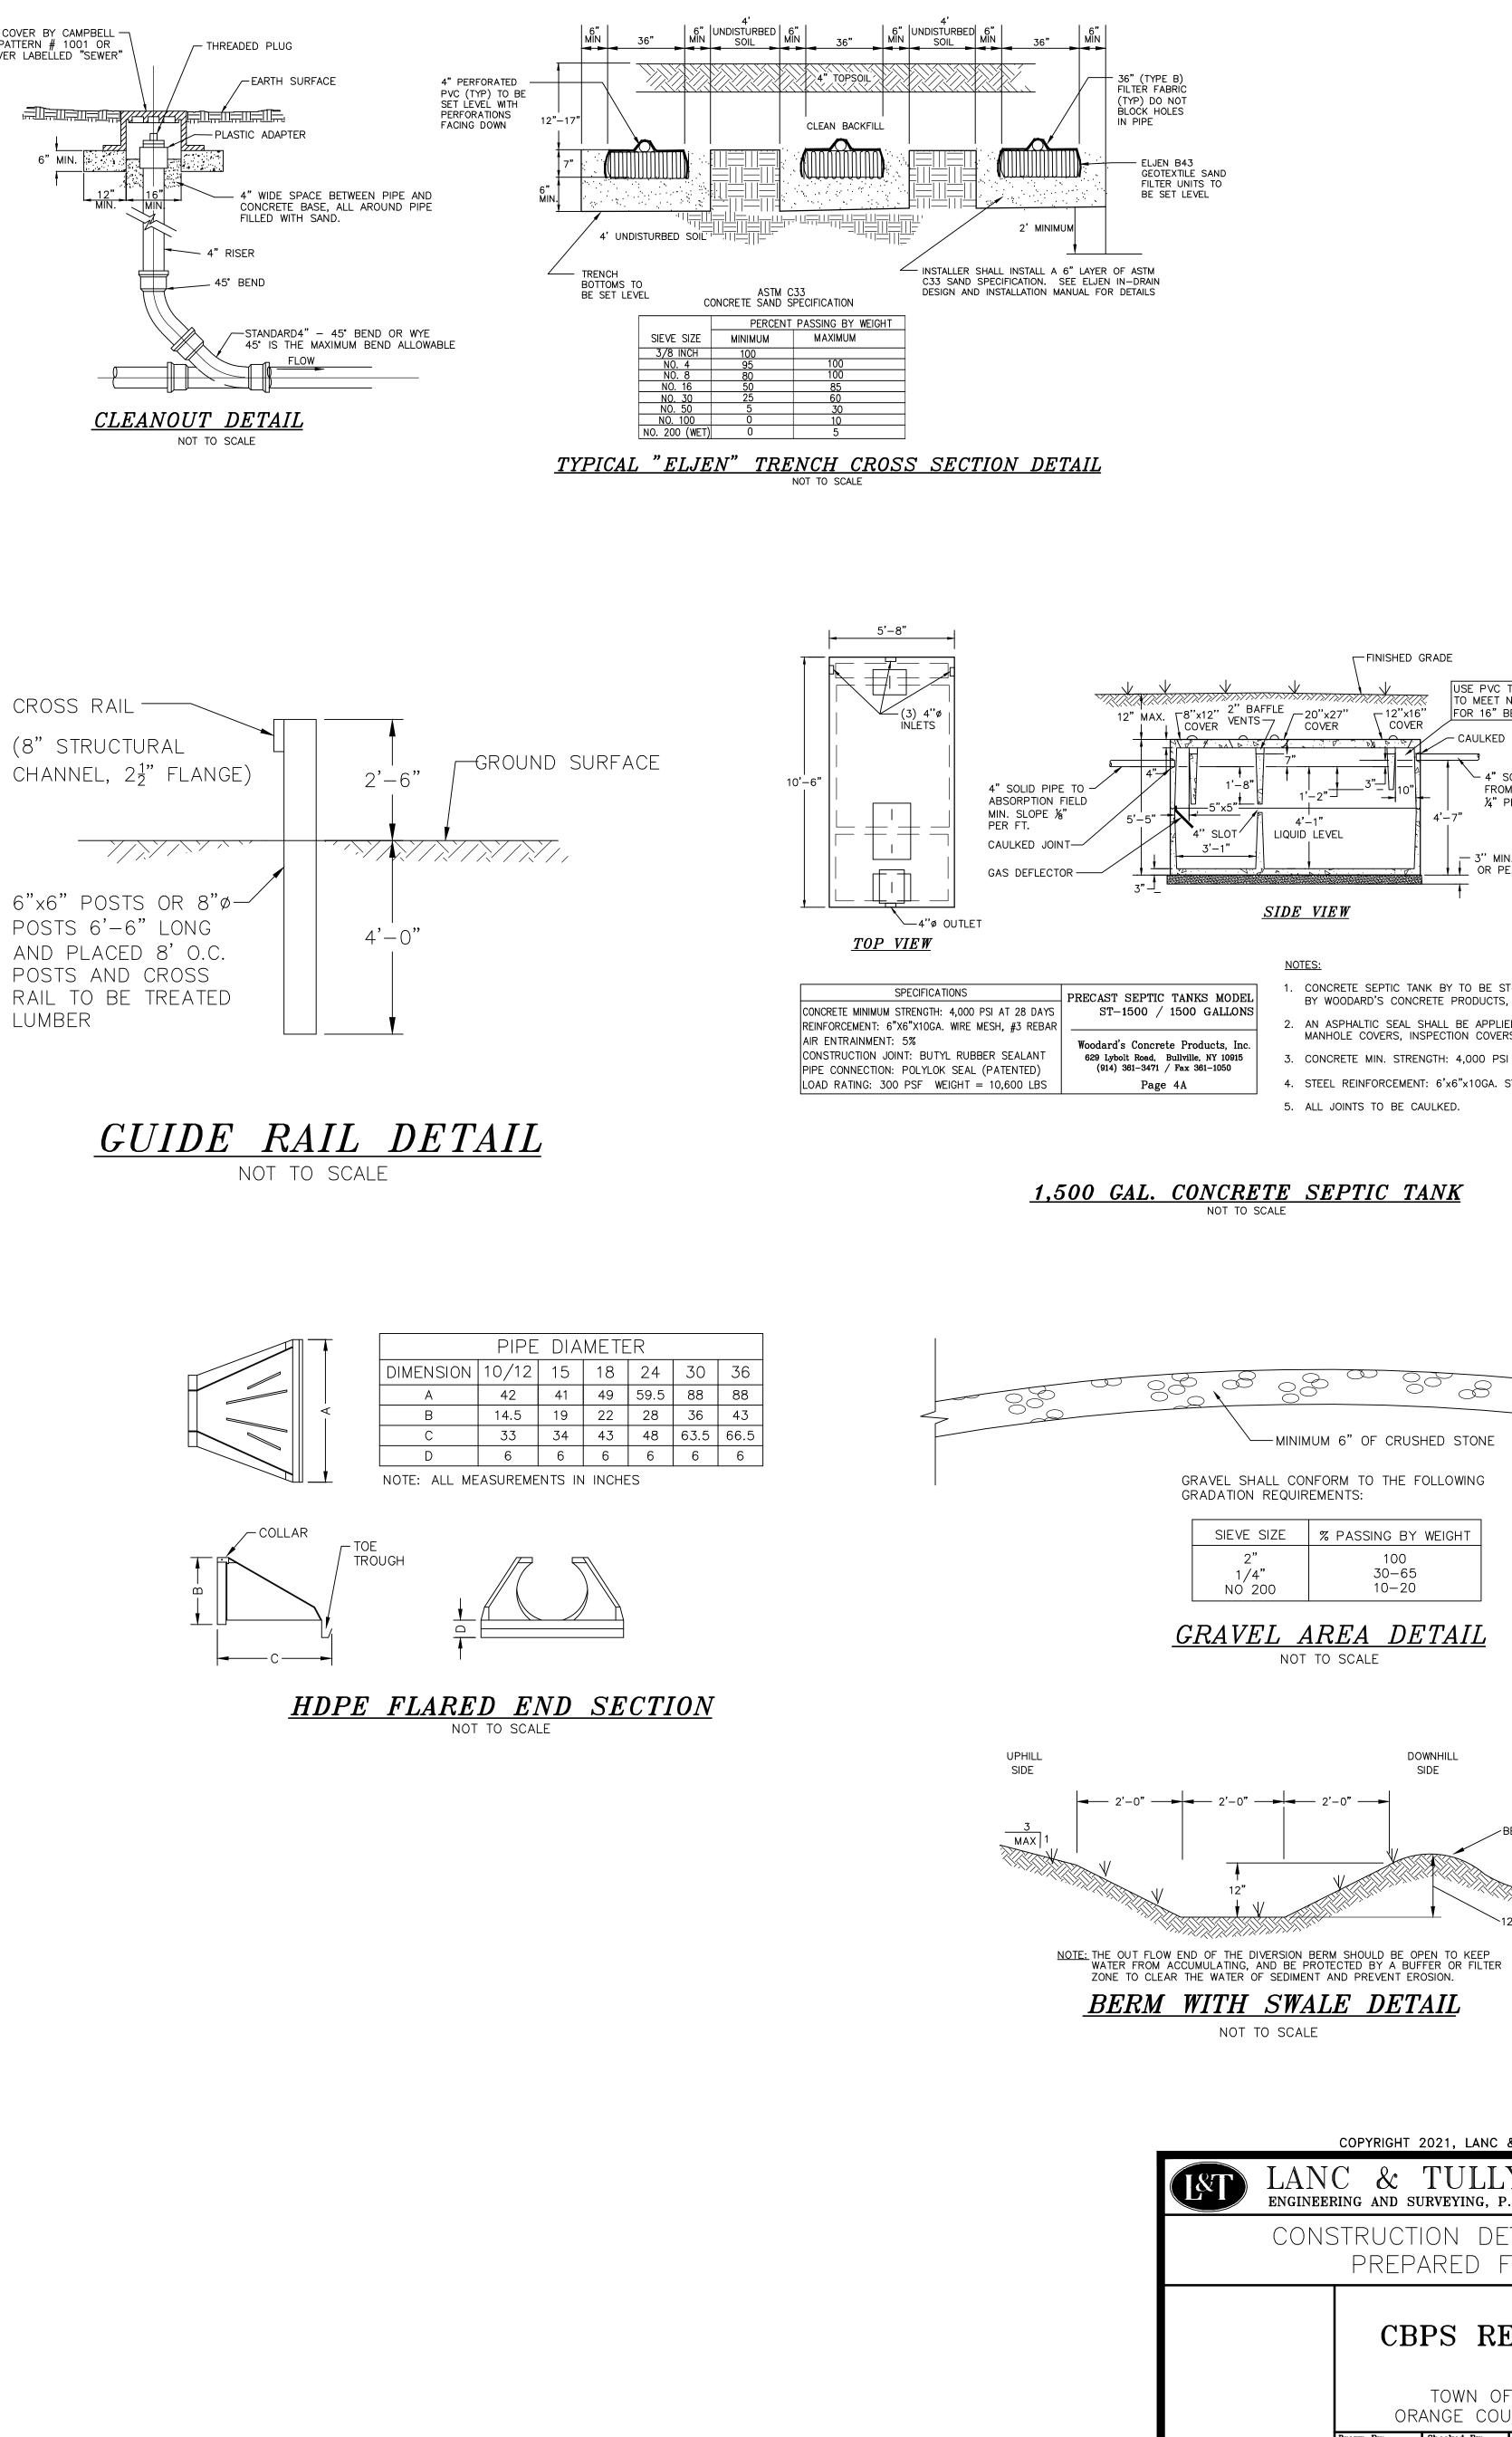12" TO 18" BERM

& TULLY, P.C			
Y .c.	Goshen, N.Y.	P.O. Box 687, Rt. 207 Goshen, N.Y. 10924 (845) 294-3700	
TAILS 2	2	Date: MAY 5, 2021	
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JNTY, NEW		Layout: DETAIL 2 Sheet No.: 6 OF 6	
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