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TOWN OF NEWBURGH PLANNING BOARD TECHNICAL REVIEW COMMENTS

PROJECT: NEWBURGH PARK ASSOCIATES(NPA) SITE PLAN

PROJECT NO.: 17-03

PROJECT LOCATION: SECTION 89, BLOCK 1, LOT 19.22

REVIEW DATE: 30 OCTOBER 2020 MEETING DATE: 5 NOVEMBER 2020

PROJECT REPRESENTATIVE: ZEN DESIGN CONSULTANT, INC.

- 1. Revised plan shows a retaining wall crossing the parcel between the two parcels owned by the subject project.
- 2. Rims and inverts of all drainage pipes should be depicted including, the 24 inch drainage pipe, existing drainage pipe at the driveway access, and the drainage pipe crossing NYS Route 747.
- **3.** Top of wall, base of wall elevations should be depicted at various locations along all proposed retaining walls.
- **4.** The Zoning Bulk Table should be addressed where the 25 foot from NYS Route 84 is depicted. Did Variance also provide for the 25 foot front yard separation from the corner lot?
- **5.** The Use of the site should be further identified as a drive up window is now proposed. Use seems to be a motor vehicle service station in accordance with Section 185-28.
- **6.** Compliance with Section 185-28 should be documented. Check location of gasoline storage facilities in association with the side yard at the corner lot.
- 7. It would appear the drive thru is a fast food service. It is only permitted in the IB Zone in association with shopping centers, theatres and Office / Research.
- **8.** Status of the Orange County Health Department approval for the subsurface sanitary sewer disposal system should be addressed.


- **9.** Notes pertaining to requiring design for all retaining walls proposed, stamped by a NYS Licensed Professional required at Building Permit.
- **10.** The pick-up window area of the building does not appear to have a canopy or cover. This should be addressed.
- **11.** Truck turning template for the fueling trucks should be identified on the site plan.
- **12.** Future submissions should identify a site landscaping plan.
- **13.** Guide rails should be identified on areas where retaining walls drop off to lower grades.
- **14.** Plans should be submitted to the New York City Department of Environmental Protection for review as they are an adjoining land owner for the Catskill Aqueduct property.
- **15.** A parking calculation should be identified on the plans in the Bulk Table.
- **16.** The building will be required to be sprinklered. Provisions for a sprinkler system are required and or a waiver sought from the Building Department.
- **17.** It is noted the site is proposed to have a well which would be considered a Community Water System and require approval from the Orange County Health Department.
- **18.** Signage on the site should be addressed in future submissions.
- **19.** The survey identifies the southerly portion of the site abutting Interstate 84 however the site abuts the ramps for Interstate 84. The survey should be further detailed to show the location of the ramps and intersection with NYS Route 747. Pavement marking, striping and other NYSDOT details within 747 should be depicted on the plans.
- **20.** Stormwater management facilities should be addressed on the site. The site would be considered a stormwater hotspot based on NYSDEC regulations for Service Stations.


Respectfully submitted,

McGoey, Hauser and Edsall Consulting Engineers, D.P.C.

Patrick J. Hines Principal

PJH/kbw

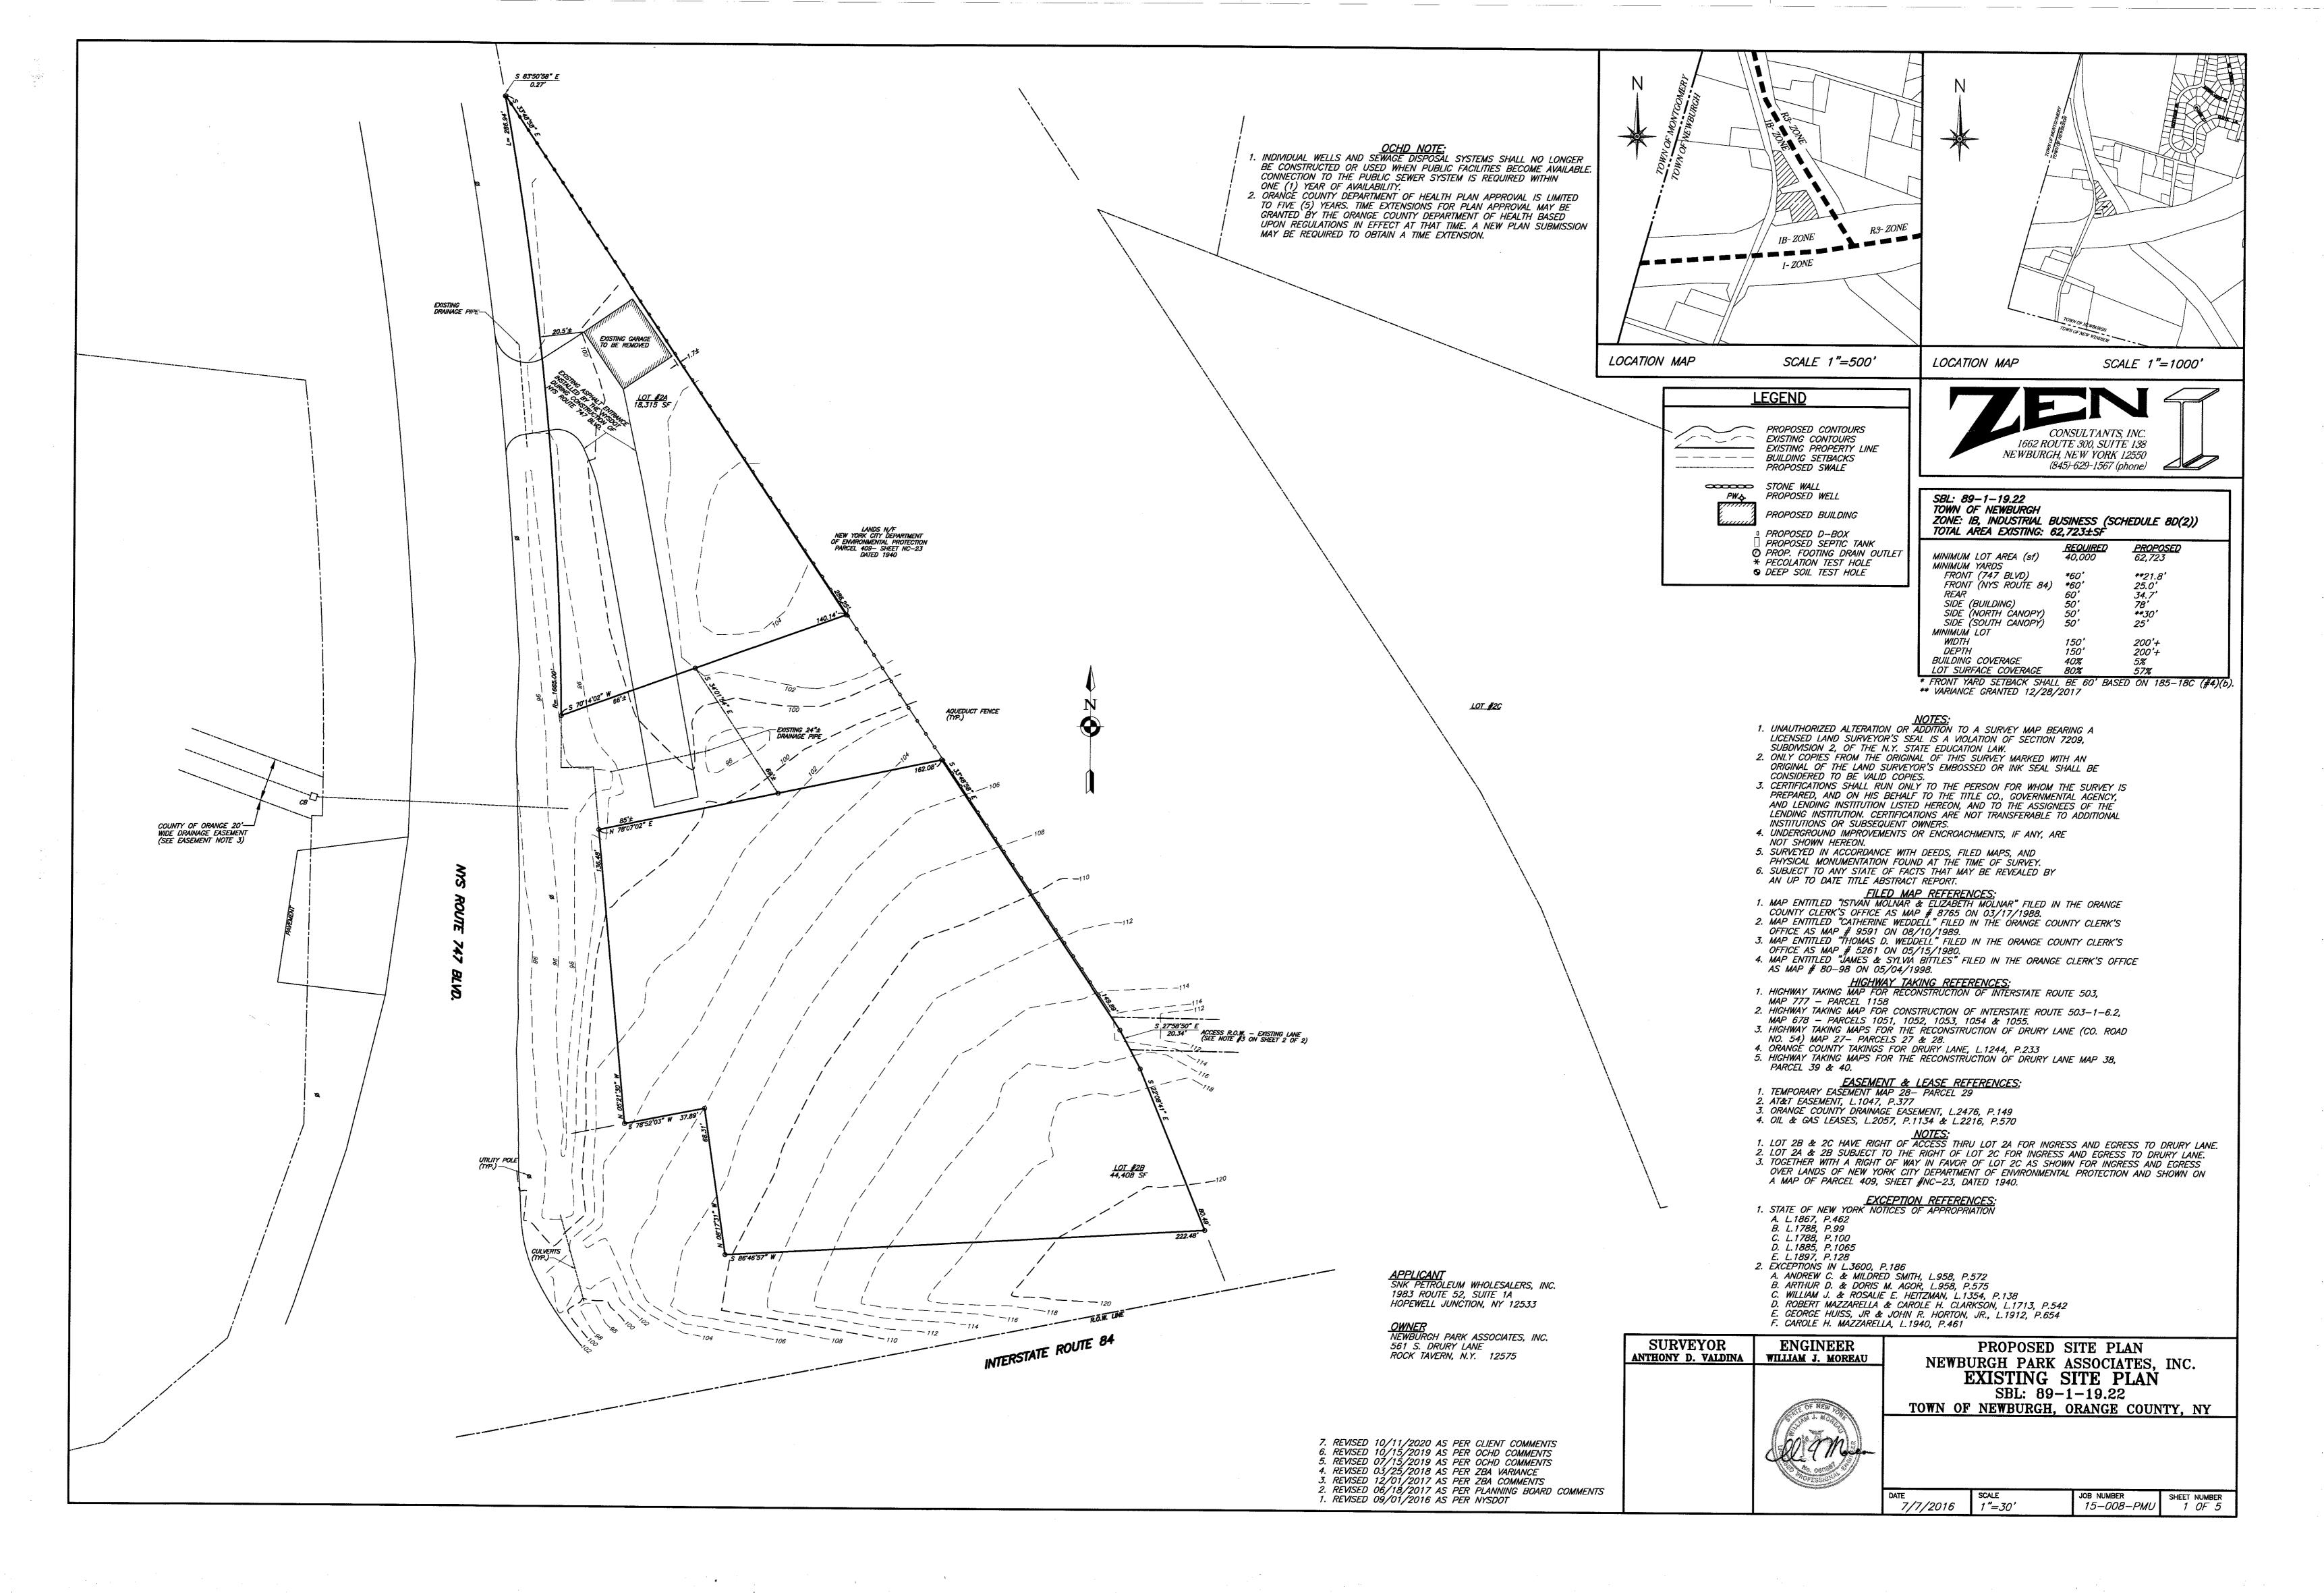

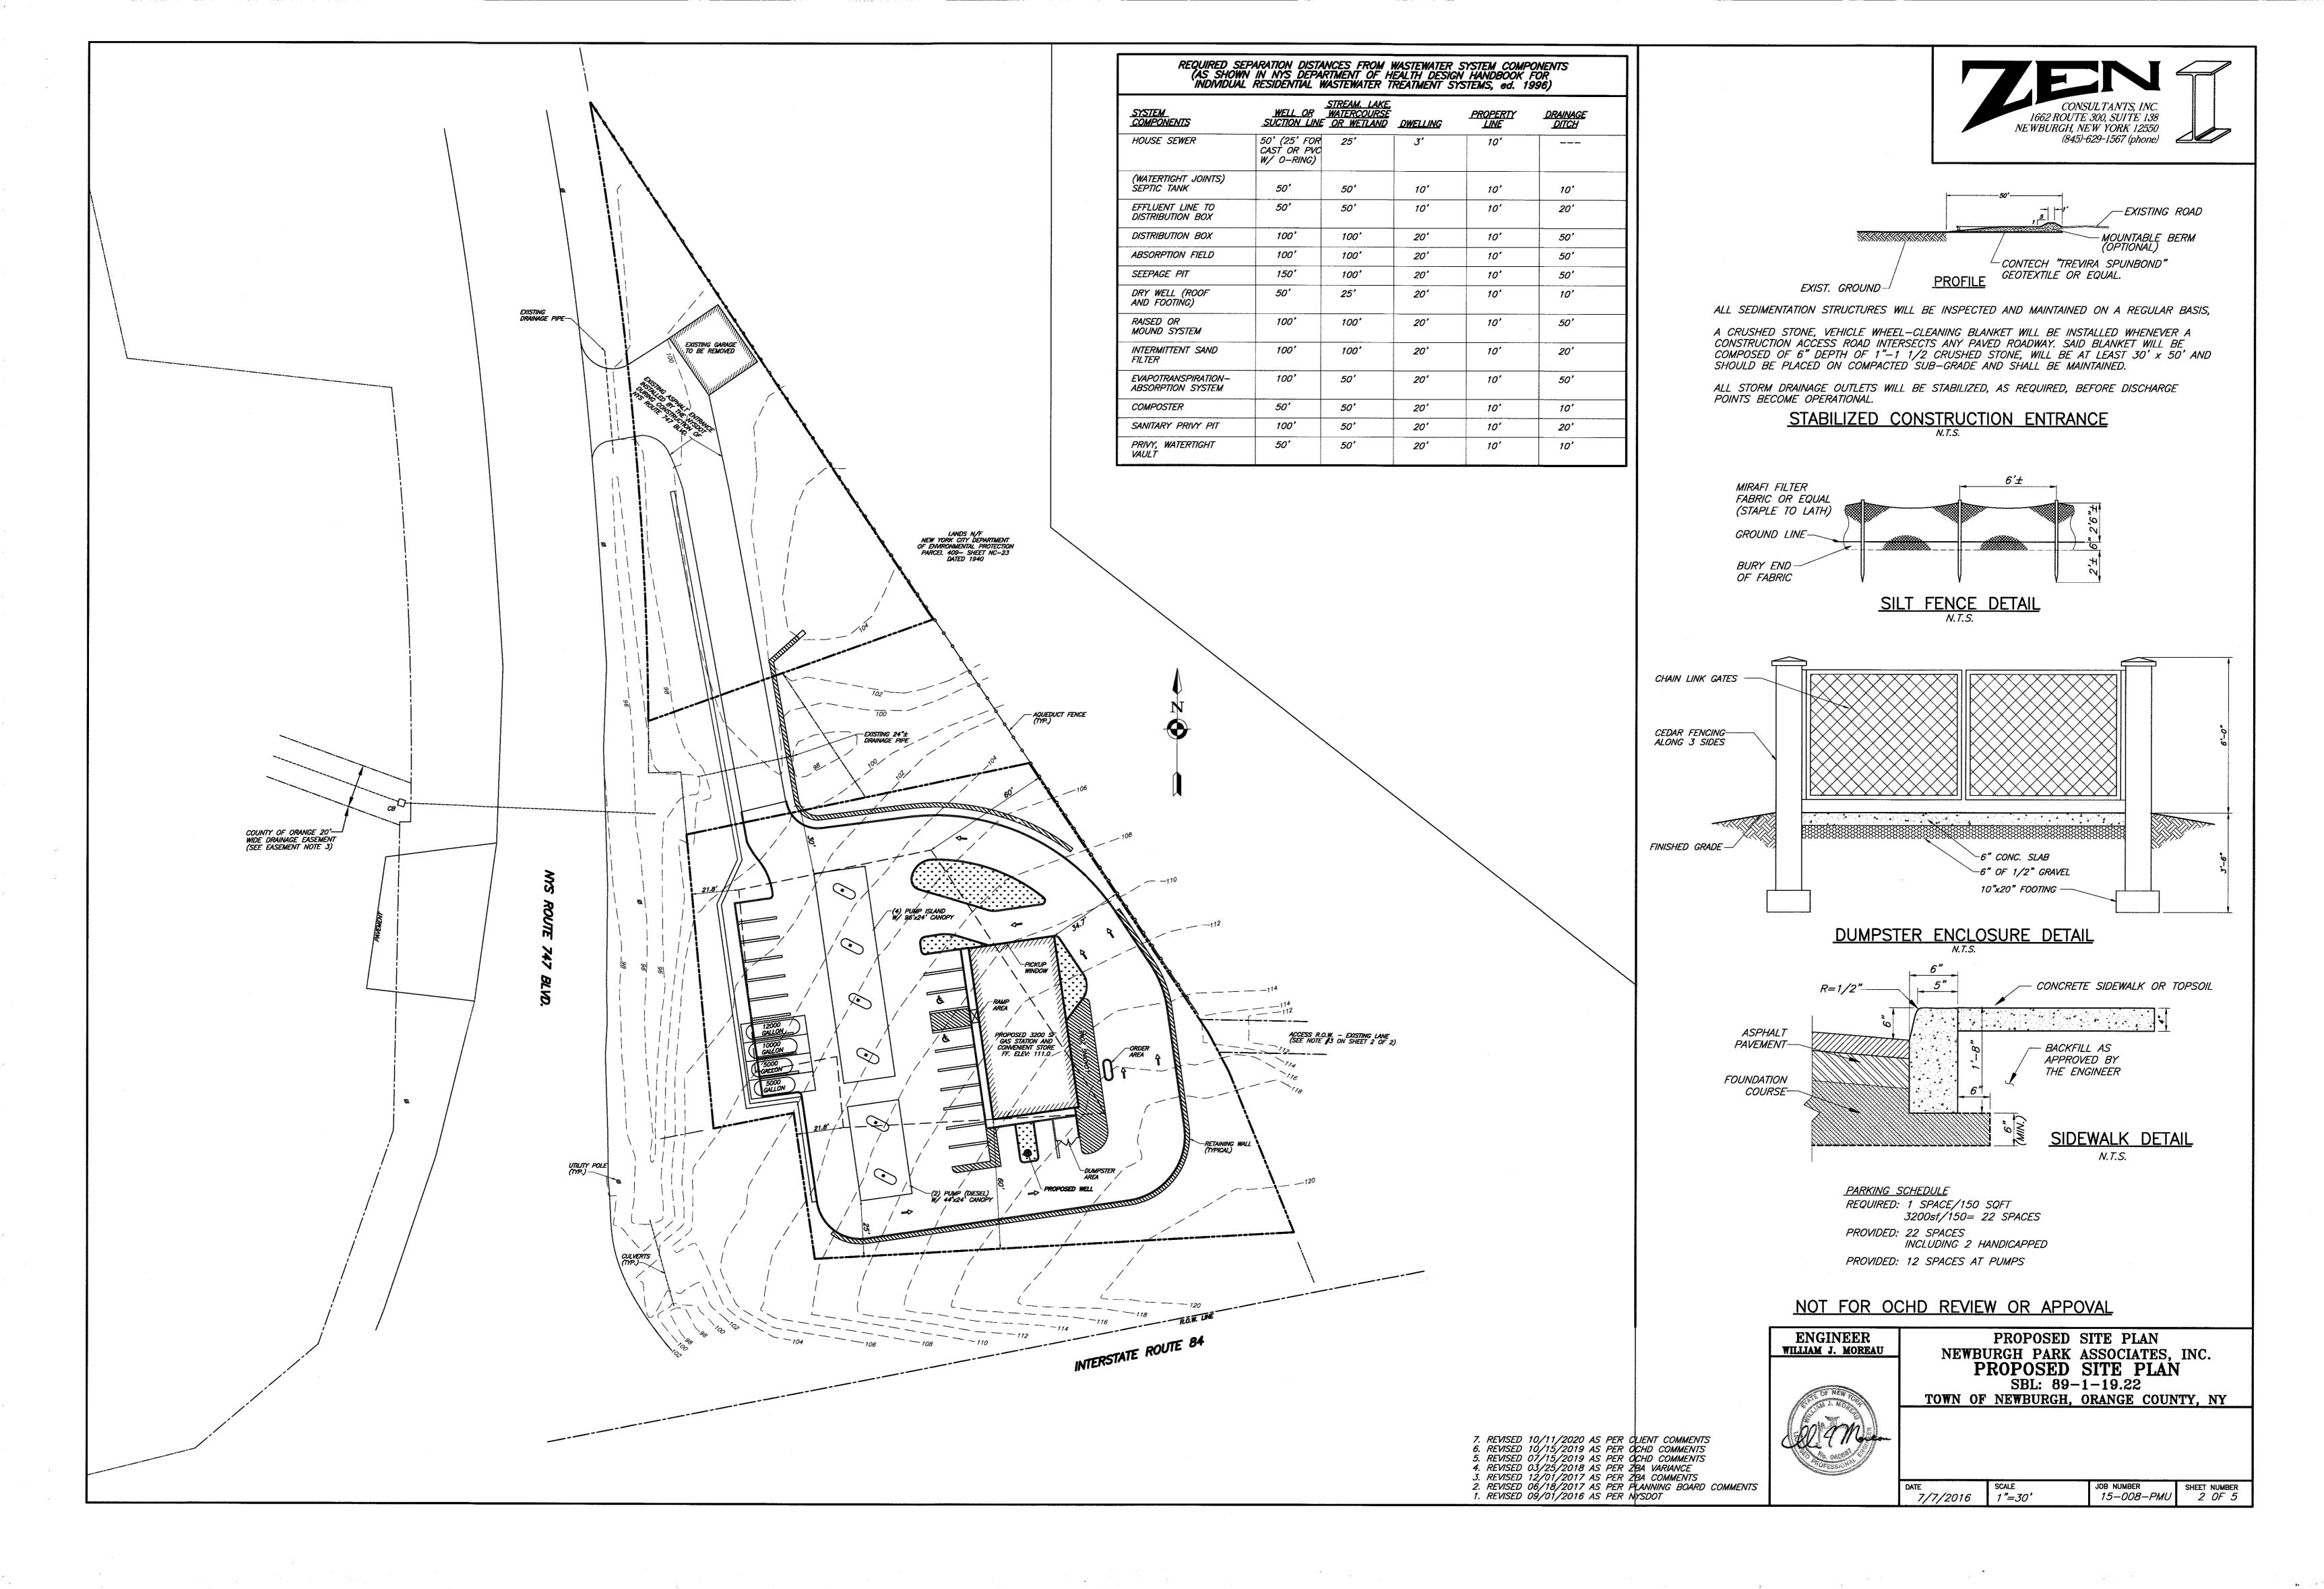



EROSION CONTROL STANDARD NOTES

- 1. EXCAVATION, FILLING, GRADING AND STRIPPING SHALL BE PERMITTED TO BE UNDERTAKEN ONLY IN SUCH LOCATIONS AND IN SUCH A MATTER AS TO MINIMIZE THE POTENTIAL OF EROSION AND SEDIMENT AND THE THREAT TO THE HEALTH, SAFETY AND WELFARE OF NEIGHBORING PROPERTY OWNERS AND THE GENERAL PUBLIC.
- 2. SITE PREPARATION AND CONSTRUCTION SHALL BE FITTED TO THE VEGETATION, TOPOGRAPHY AND OTHER NATURAL FEATURES OF THE SITE AND SHALL PRESERVE AS MANY OF THESE FEATURES AS FEASIBLE.
- 3. THE CONTROL OF EROSION AND SEDIMENT SHALL BE A CONTINUOUS PROCESS UNDERTAKEN AS NECESSARY PRIOR TO, DURING AND AFTER SITE PREPARATION AND CONSTRUCTION.
- 4. THE SMALLEST PRACTICAL AREA OF LAND SHALL BE EXPOSED BY SITE PREPARATION AT ANY GIVEN TIME.
- 5. THE EXPOSURE OF AREAS BY SITE PREPARATION SHALL BE KEPT TO THE SHORTEST PRACTICAL PERIOD OF TIME PRIOR TO THE CONSTRUCTION OF STRUCTURES OR IMPROVEMENTS OR THE RESTORATION OF THE EXPOSED AREAS TO AN ATTRACTIVE NATURAL

CONDITION.

- 6. MULCHING OR TEMPORARY VEGETATION SUITABLE TO THE SITE SHALL BE USED WHERE NECESSARY TO PROTECT AREAS EXPOSED BY SITE PREPARATION, AND PERMANENT VEGETATION WHICH IS WELL ADAPTED
- TO THE SITE SHALL BE INSTALLED AS SOON AS PRACTICAL. 7. WHERE SLOPES ARE TO BE REVEGETATED IN AREAS EXPOSED BY SITE PREPARATION, THE SLOPES SHALL NOT BE OF SUCH STEEPNESS THAT VEGETATION CANNOT BE READILY ESTABLISHED OR THAT PROBLEMS OF EROSION OR SEDIMENT MAY RESULT.
- 8. SITE PREPARATION AND CONSTRUCTION SHALL NOT ADVERSELY AFFECT THE FREE FLOW OF WATER BY ENCROACHING ON, BLOCKING OR RESTRICTING WATERCOURSES.
- 9. ALL FILL MATERIAL SHALL BE COMPOSITION SUITABLE FOR THE ULTIMATE USE OF THE FILL, FREE OF RUBBISH AND CAREFULLY RESTRICTED IN ITS CONTENT OF BRUSH, STUMPS, TREE DEBRIS, ROCKS, FROZEN MATERIAL AND SOFT OR EASILY COMPRESSIBLE MATERIAL.
- 10. FILL MATERIAL SHALL BE COMPACTED SUFFICIENTLY TO PREVENT PROBLEMS OF EROSION, AND WHERE THE MATERIAL IS TO SUPPORT STRUCTURES, IT SHALL BE COMPACTED TO A MINIMUM OF NINETY PERCENT (90%) OF STANDARD PROCTOR WITH PROPER MOISTURE CONTROL.
- 11. ALL TOPSOIL WHICH IS EXCAVATED FROM A SITE SHALL BE STOCKPILED AND USED FOR THE RESTORATION OF THE SITE, AND SUCH STOCKPILES, WHERE NECESSARY, SHALL BE SEEDED OR OTHERWISE TREATED TO MINIMIZE THE EFFECTS OF EROSION.
- 12. PRIOR TO, DURING AND AFTER SITE PREPARATION AND CONSTRUCTION, AN INTEGRATED DRAINAGE SYSTEM SHALL BE PROVIDED WHICH AT ALL TIMES MINIMIZES EROSION, SEDIMENT, HAZARDS OF SLOPE INSTABILITY AND ADVERSE EFFECT ON NEIGHBORING PROPERTY OWNERS.
- 13. THE NATURAL DRAINAGE SYSTEM SHALL GENERALLY BE PRESERVED IN PREFERENCE TO MODIFICATIONS OF THIS SYSTEM, EXCEPTING WHERE SUCH MODIFICATIONS ARE NECESSARY TO REDUCE LEVELS OF EROSION AND SEDIMENT AND ADVERSE EFFECTS ON NEIGHBORING PROPERTY
- 14. ALL DRAINAGE SYSTEMS SHALL BE DESIGNED TO HANDLE ADEQUATELY ANTICIPATED FLOWS, BOTH WITHIN THE SITE AND FROM THE ENTIRE UPSTREAM DRAINAGE BASIN.
- 15. SUFFICIENT GRADES AND DRAINAGE FACILITIES SHALL BE PROVIDED TO PREVENT THE PONDING OF WATER, UNLESS SUCH PONDING IS PROPOSED WITHIN SITE PLANS, IN WHICH EVENT THERE SHALL BE SUFFICIENT WATER FLOW TO MAINTAIN PROPOSED WATER LEVELS AND TO AVOID STAGNATION. 16. THERE SHALL BE PROVIDED WHERE NECESSARY TO MINIMIZE
- EROSION AND SEDIMENT SUCH MEASURES AS BENCHES, BERMS, TERRACES, DIVERSIONS AND SEDIMENT, DEBRIS AND RETENTION BASINS.
- 17. DRAINAGE SYSTEMS, PLANTINGS AND OTHER EROSION OR SEDIMENT CONTROL DEVICES SHALL BE MAINTAINED AS FREQUENTLY AS NECESSARY TO PROVIDE ADEQUATE PROTECTION AGAINST EROSION AND SEDIMENT AND TO ENSURE THAT THE FREE FLOW OF WATER IS NOT OBSTRUCTED BY THE ACCUMULATION OF SILT, DEBRIS OR OTHER MATERIAL OR BY STRUCTURAL DAMAGE.

7. REVISED 10/11/2020 AS PER CLIENT COMMENTS
6. REVISED 10/15/2019 AS PER OCHD COMMENTS
5. REVISED 07/15/2019 AS PER OCHD COMMENTS
4. REVISED 03/25/2018 AS PER ZBA VARIANCE
3. REVISED 12/01/2017 AS PER ZBA COMMENTS
2. REVISED 06/18/2017 AS PER PLANNING BOARD COMMENTS
1. REVISED 09/01/2016 AS PER NYSDOT


ENGINEER WILLIAM J. MOREAU


PROPOSED SITE PLAN NEWBURGH PARK ASSOCIATES, INC. DRAINAGE & GRADING SBL: 89-1-19.22 TOWN OF NEWBURGH, ORANGE COUNTY, NY


1"=30'

7/7/2016

SHEET NUMBER 15-008-PMU 3 OF 5

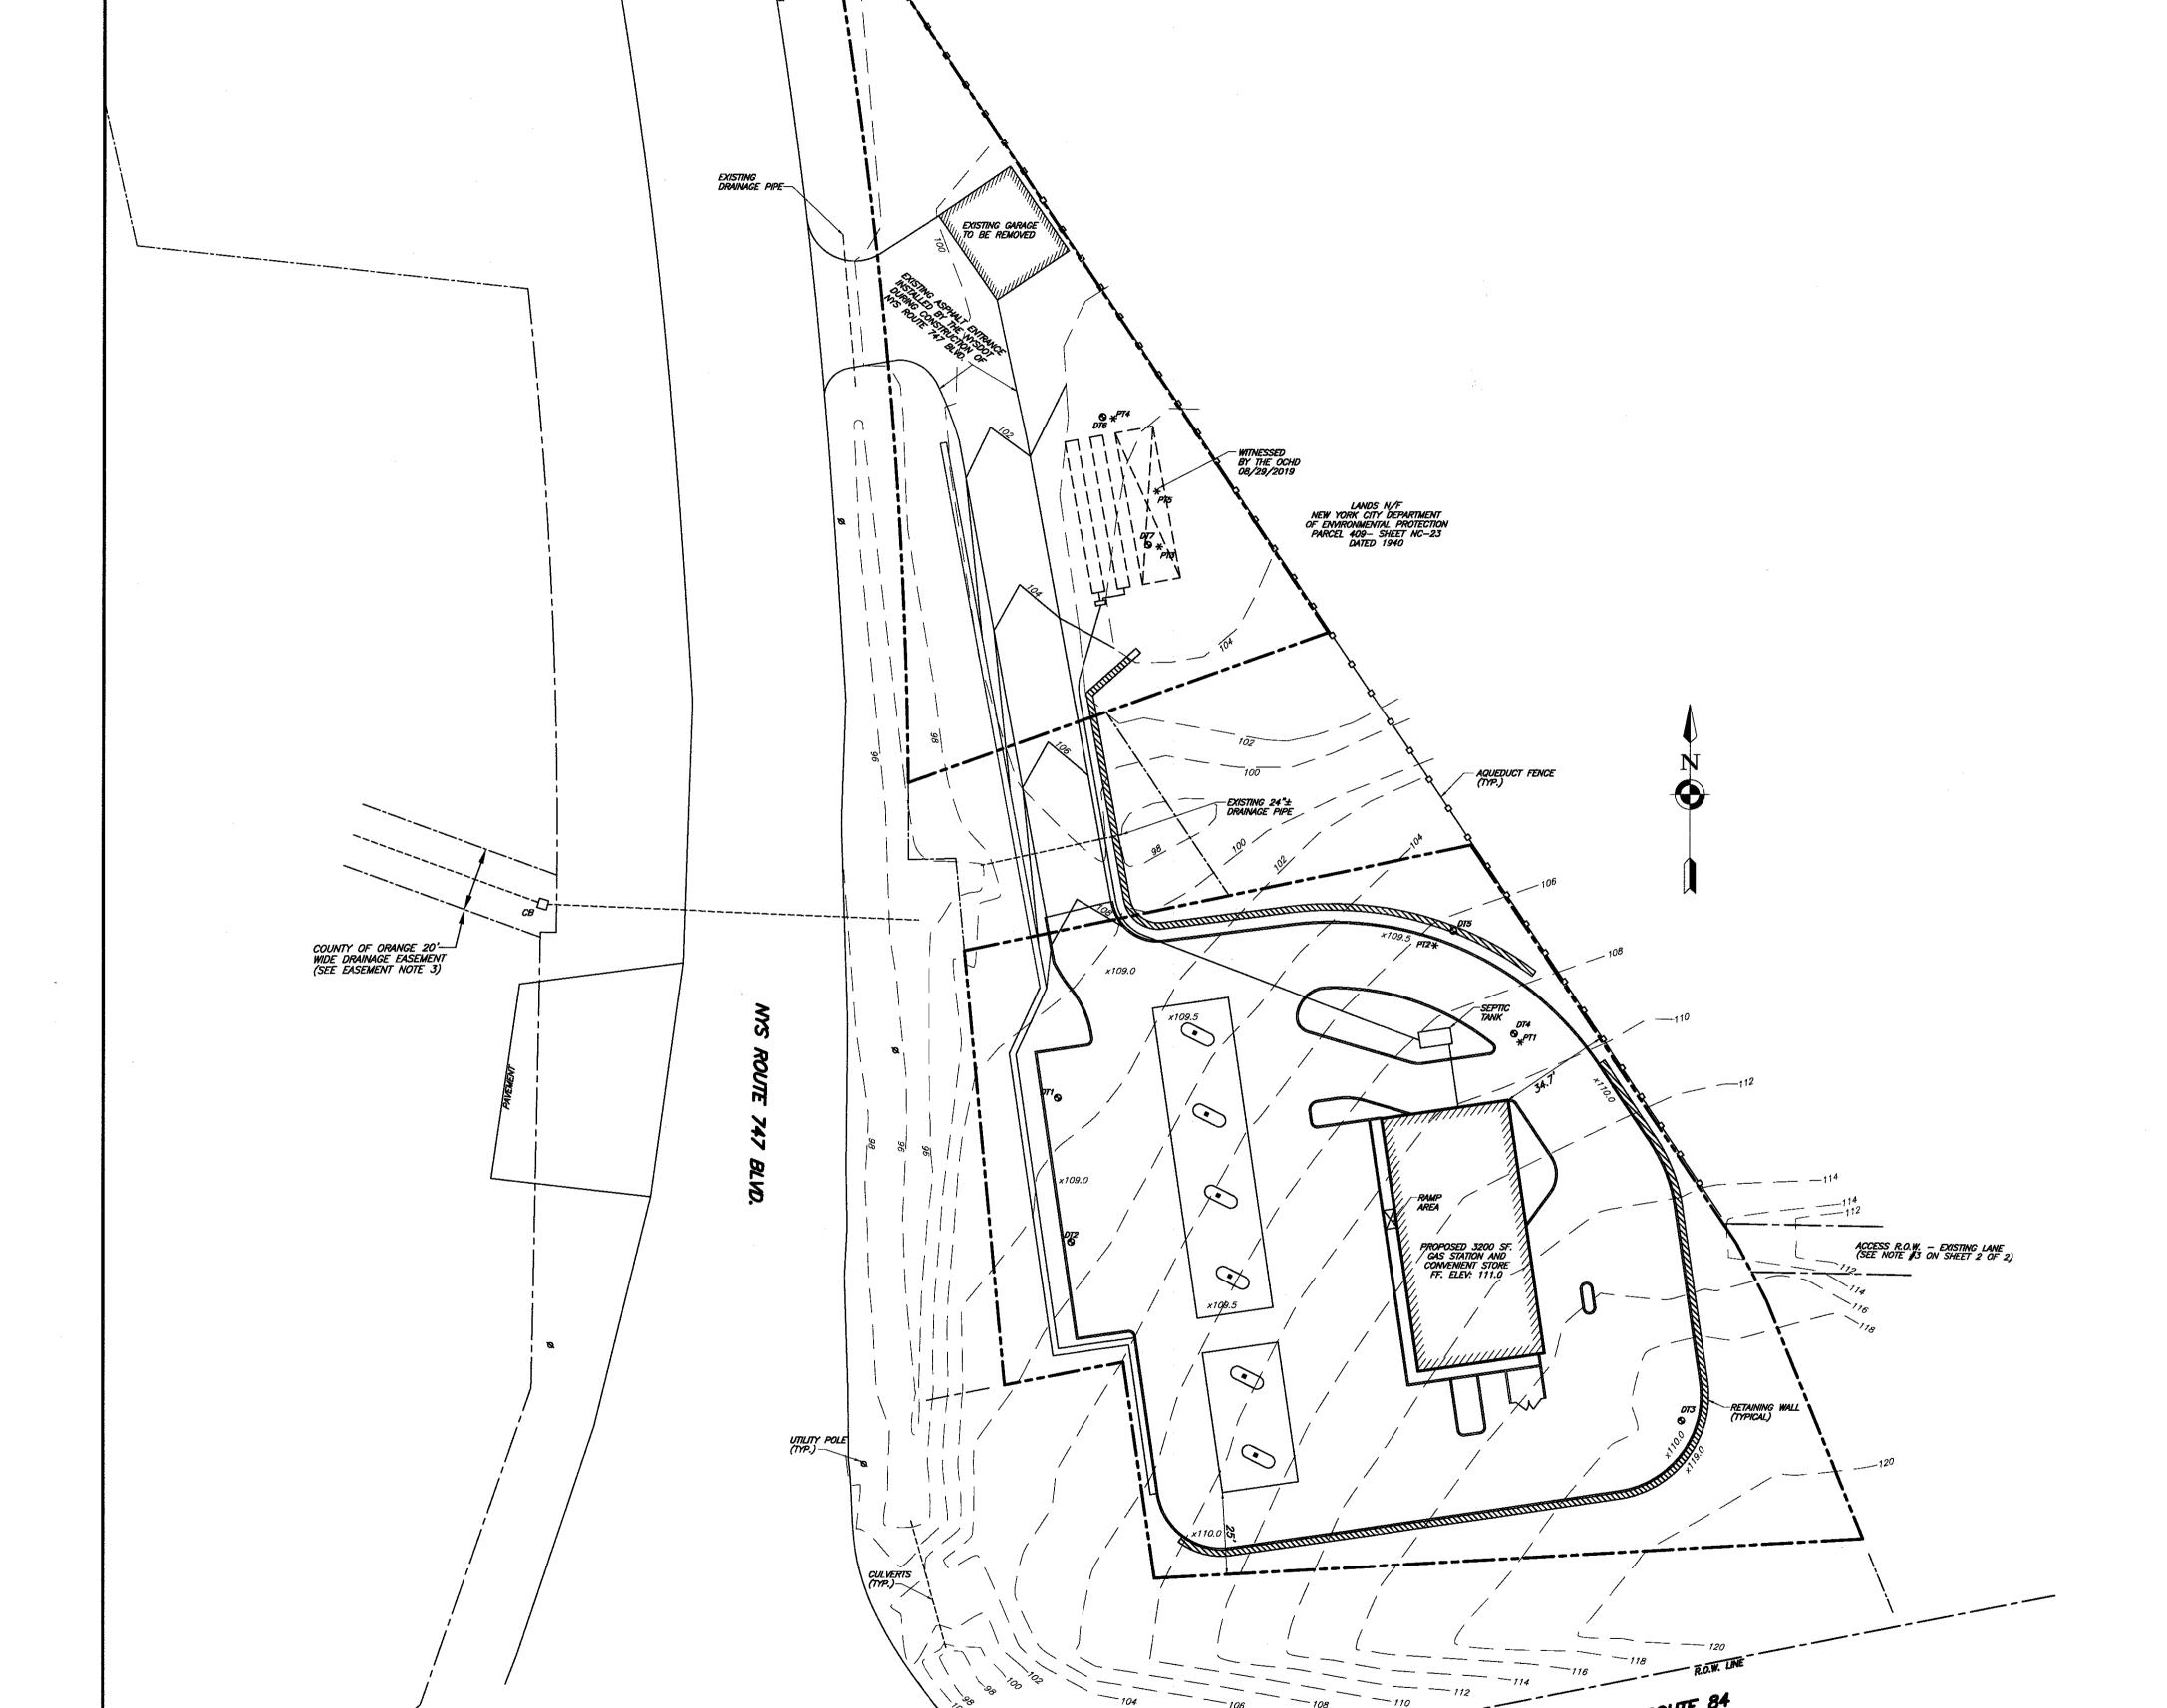

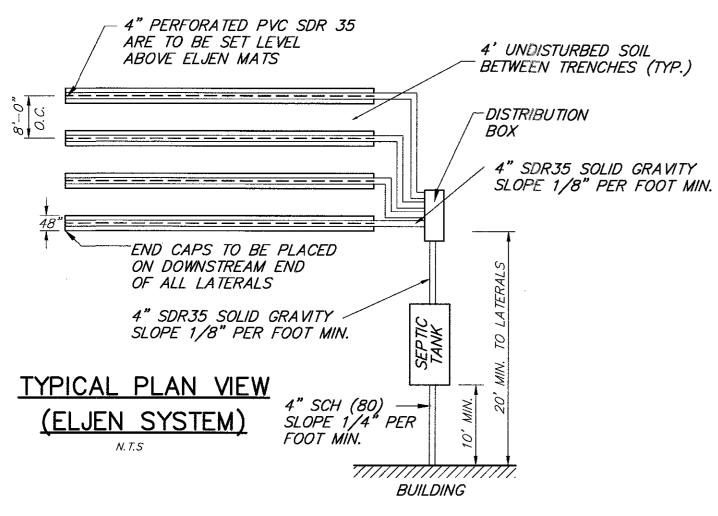

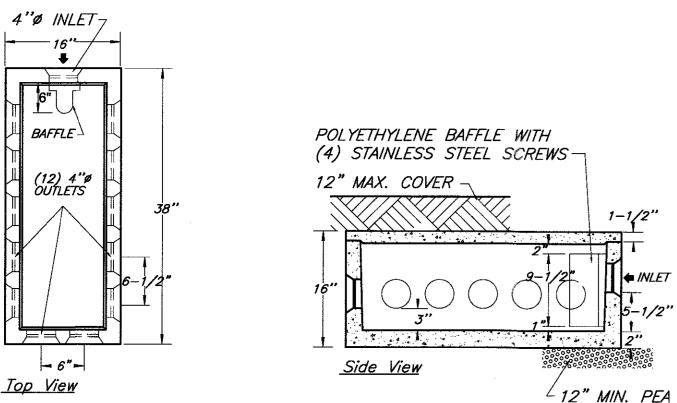


WOODARDS 12-HOLE DISTRIBUTION BOX N.T.S.


SPECIFICATIONS
CONCRETE MINIMUM STRENGTH— 4,000 PSI AT 28 DAYS REINFORCEMENT— 6"x6"10GA. WWF, #4 REBAR
AIR ENTRAPMENT— 5% CONSTRUCTION JOINT— BUTYL RUBBER — BASE CEMENT PIPE CONNECTION— POLYLOC SEAL (PATENTED)
LOAD RATING- 300PSF WEIGHT = 325LBS

OUTLETS ARE TO BE SET AT THE SAME ELEVATION AND FLOW EQUALIZERS ARE REQUIRED 2. OUTLETS MUST BE USED IN A MANNER THAT WILL ALLOW ACCESS TO THE EXPANSION AREA WITHOUT DISTURBING EXISTING PIPING

GRAVEL OR SAND

- 1. FLOW EQUALIZERS ARE REQUIRED ON ALL OUTLETS 2. ALL OUTLETS MUST BE SET AT THE SAME ELEVATION
- 3. OUTLETS MUST BE USED IN A MANNER THAT WILL ALLOW ACCESS TO THE EXPANSION AREA WITHOUT DISTURBING EXISTING PIPING.

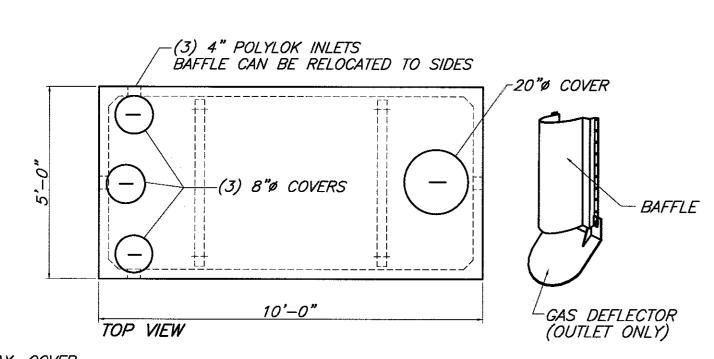


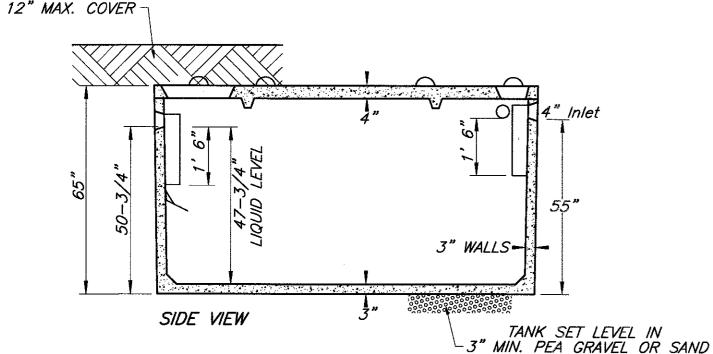

SPECIFICATIONS CONCRETE MINIMUM STRENGTH- 4,000 PSI AT 28 DAYS REINFORCEMENT: #4 BAR GR. 60, FORTA FERRO 5 LB/CY AIR ENTRAPMENT- 6% CONSTRUCTION JOINT: BUTYL RUBBER SEALANT PIPE CONNECTION- POLYLOK SEAL (PATENTED) H20 LOADING ON REQUEST


WOODARD ST-1250 SEPTIC TANK OR EQUAL

REQUIRED SEPARATION DISTANCES FROM WASTEWATER SYSTEM COMPONENTS (AS SHOWN IN NYS DEPARTMENT OF HEALTH DESIGN HANDBOOK FOR INDIVIDUAL RESIDENTIAL WASTEWATER TREATMENT SYSTEMS, ed. 1996) SYSTEM COMPONENTS <u>DRAINAGE</u> <u>DITCH</u> WATERCOURS PROPERTY LINE SUCTION LINE OR WETLAND HOUSE SEWER 50' (25' FOR CAST OR PVC W/O-RING)(WATERTIGHT JOINTS) SEPTIC TANK *50'* 10' 10' 10' EFFLUENT LINE TO *50'* 10' 10' 20' DISTRIBUTION BOX DISTRIBUTION BOX 100' 100' 20° 10' ABSORPTION FIELD 100' 100' 20' 10 *50'* SEEPAGE PIT 150' 100' 20' 10' *50'* DRY WELL (ROOF *50*′ 25 10' 20' AND FOOTING) RAISED OR 100' 100' 20' 10' MOUND SYSTEM INTERMITTENT SAND 100' 100' 20' 10' FILTER EVAPOTRANSPIRATION-100' 10' ABSORPTION SYSTEM COMPOSTER *50*' 50 10 SANITARY PRIVY PIT 100' 20' 10' 20 PRIVY, WATERTIGHT *50'* 20' 10 10' VAULT

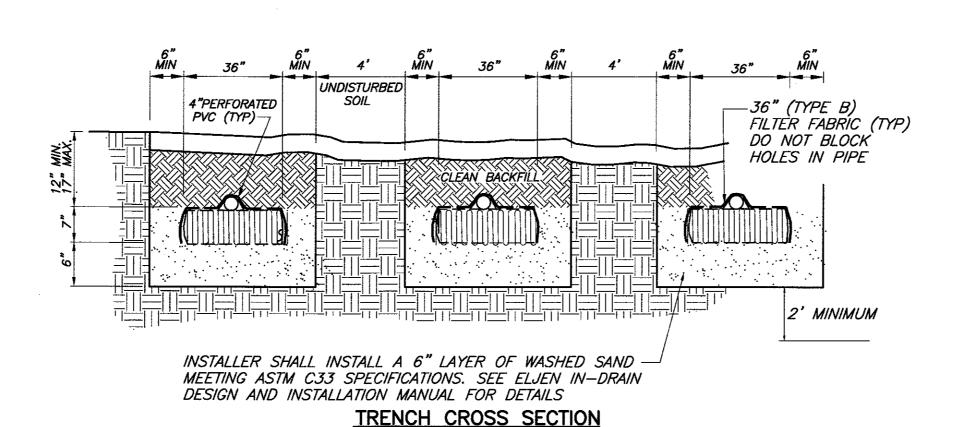


FOR ELJEN SYSTEM

N.T.S.

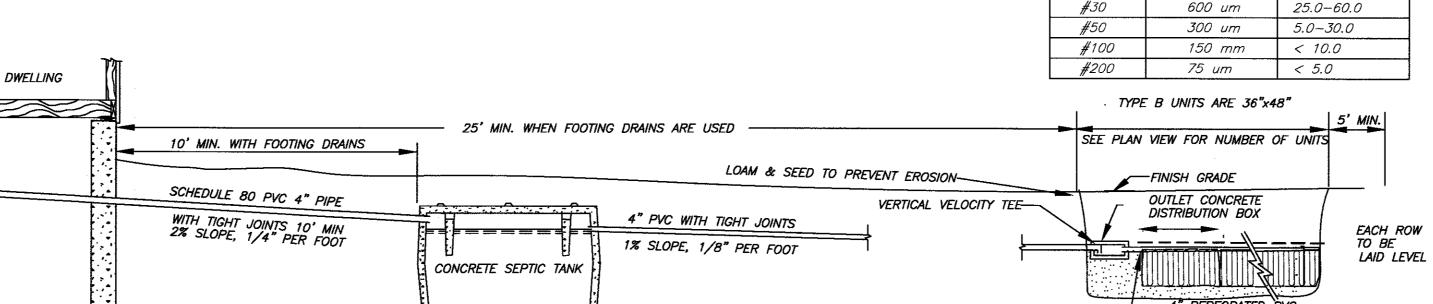

TYPICAL SECTION OF ELJEN IN-DRAIN SYSTEM

SEPTIC SYSTEM DESIGN DATA:

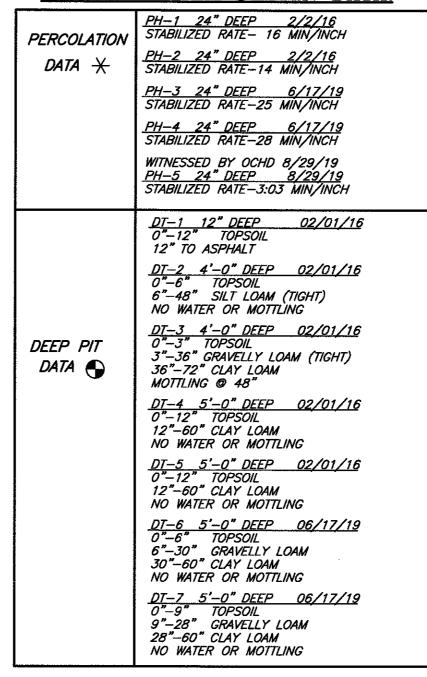

DESIGN RATE (GPD/SF): 3,200 SF BUILDING SIZE TOTAL (GAS STATION) 400 GPD APPLICATION RATE (400/TOILET)


LOW FLOW FIX. -20% REDUCTION -80 GPD TOTAL 320 GPD

SEPTIC TANK DESIGN: (320x 1.5)=480 GAL. GALLONS: TANK SIZE PROV'D: 1250 GAL.

SYSTEM DESIGN: GALLONS PER DAY: 320 GPD PERCOLATION RATE: 28 MIN/IN. APPLICATION RATE: 0.60 GPD/SF. SQ. FT. REQUIRED: 534 SF FT. OF TRENCH:

89 LF. REQ'D PRV'D 96 LF - 2@48'

TOTAL 400 GPD

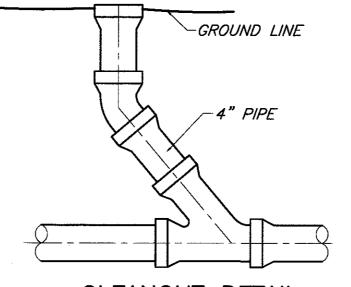

CLEANOUT DETAIL

1. TO BE INSTALLED EVERY 75' (MIN.) & AT BENDS OF 45° OR GREATER.

ASTM C33

SAND SPECIFICATION

SIEVE SQ.

OPNG. SIZE

9.5 mm

4.75 mm

SIEVE SIZE

0.375"

- 2. TO BE INSTALLED BEFORE BEND AT ALL BEND LOCATIONS. 3. TO BE INSTALLED WHERE PIPE DEFLECTION EXCEEDS 15° AT INTERSECTION WITH CONCRETE TANKS
- 4. TO BE INSTALLED AT 90° BENDS IN THE EFFLUENT LINE BETWEEN THE SEPTIC TANK AND D-BOX. WHERE POSSIBLE (2) 45° BENDS ARE TO BE INSTALLED WITH A MINIMUM OF 2' OF SOLID PIPE BETWEEN THE BENDS.

SPEC. % PASSING

(WET SIEVE)

100.0-100.0

95.0-100.0

t	<i>"</i>	•	1 33.0 700.0
	#8	2.36 mm	80.0-100.0
	#16	1.18 mm	50.0-85.0
	#30	600 um	25.0-60.0
	#50	300 um	5.0~30.0
	#100	150 mm	< 10.0
	#200	75 um	< 5.0
·	SEE PLAN	I VIEW FOR NUMBER	OF UNITS
		-FINISH GRADE	
<u> </u>	<u> </u>	OUTLET CONCRETE DISTRIBUTION BOX	
,		. "	EACH ROW
<u></u>			TO BE
ı	ر السببار		

7. REVISED 10/11/2020 AS PER CLIENT COMMENTS 6. REVISED 10/15/2019 AS PER OCHD COMMENTS 5. REVISED 07/15/2019 AS PER OCHD COMMENTS 4. REVISED 03/25/2018 AS PER ZBA VARIANCE 3. REVISED 12/01/2017 AS PER ZBA COMMENTS 2. REVISED 06/18/2017 AS PER PLANNING BOARD COMMENTS
1. REVISED 09/01/2016 AS PER NYSDOT

1662 ROUTE 300, SUITE 138 NEWBURGH, NEW YORK 12550 (845)-629-1567 (office)

SEPTIC SYSTEM GENERAL NOTES:

- 1. ALL PORTIONS OF THE SEPTIC FIELD WILL BE A MINIMUM DISTANCE OF 200 FEET UP SLOPE AND 100 FEET DOWN SLOPE FROM ANY WELL.
- 2. SEPTIC TANK TO BE LOCATED A MINIMUM DISTANCE OF 10 FEET FROM ANY BUILDING OR PROPERTY LINE.
- 3. CELLAR DRAINS, ROOF DRAINS OR FOOTING DRAINS SHALL NOT BE DISCHARGED IN THE VICINITY OF ABSORPTION FIELD.
- 4. NO SWIMMING POOLS. DRIVEWAYS, OR STRUCTURES THAT MAY COMPACT THE SOIL SHALL NOT BE CONSTRUCTED OVER ANY PORTION OF THE ABSORPTION FIELD. NO TRENCHES TO BE INSTALLED IN WET SOIL.
- RAKE SIDES AND BOTTOM OF TRENCH PRIOR TO PLACING GRAVEL IN
- ABSORPTION TRENCH. GROUT ALL PIPE PENETRATIONS TO CONC. SEPTIC TANK & DISTRIBUTION BOX.
- DISTRIBUTION LINE ARE TO BE CAPPED. THE PERIMETER OF THE ABSORPTION FIELD SHOULD BE GRADED TO DIVERT
- SURFACE WATER. 10. ALL NEWLY DISTURBED AREAS SHALL BE IMMEDIATELY STABILIZED UPON
- CONSTRUCTION COMPLETION USING GRASS SEED & MULCH. 11. NO SEWAGE SYSTEM SHALL BE PLACED WITH IN 35' OF ANY WATER COURSE
- DRAINAGE DITCH. 12. ALL LAUNDRY AND KITCHEN WASTES SHALL BE DISCHARGED INTO SEWAGE
- SYSTEM. 13. BENDS SHALL BE USED WHEN ENTRANCE OR EXIT FROM SEPTIC TANK IS NOT APPROXIMATELY STRAIGHT. IF BENDS ARE USED AT POINTS OTHER
- THAN ENTRANCE OR EXIT POINTS, THEN A CLEANOUT IS REQUIRED. 14. THE DESIGN AND LOCATION OF THE SANITARY FACILITIES SHALL NOT BE CHANGED WITHOUT RESUBMISSION FOR APPROVAL.
- 15. HEAVY EQUIPMENT SHALL BE KEPT OFF THE AREA OF THE ABSORPTION FIELDS EXCEPT DURING THE ACTUAL CONSTRUCTION. THERE SHALL BE NO UNNECESSARY MOVEMENT OF CONSTRUCTION EQUIPMENT IN THE ABSORPTION FIELD AREA BEFORE. DURING. OR AFTER CONSTRUCTION. EXTREME CARE MUST BE TAKEN DURING CONSTRUCTION SO AS TO AVOID ANY UNDUE COMPACTION THAT COULD RESULT IN A CHANCE OF THE ABSORPTION CAPACITY OF THE SOIL ON WHICH THE DESIGN WAS BASED.
- 16. THIS SYSTEM WAS NOT DESIGNED TO ACCOMMODATE GARBAGE GRINDERS, JACUZZI TYPE SPA TUBS OVER 100 GALLONS, OR WATER CONDITIONERS AS SUCH, THESE ITEMS SHALL NOT BE INSTALLED UNLESS THE SYSTEM IS REDESIGNED TO ACCOUNT FOR THESE.
- 17. THERE MUST BE AN UNINTERRUPTED POSITIVE SLOPE FROM THE SEPTIC TANK (OR ANY PUMPING OR DOSING CHAMBER) TO THE HOUSE, ALLOWING SEPTIC GASES TO DISCHARGE THROUGH THE STACK VENT.
- 18. THE OWNER/APPLICANT SHALL BE PROVIDED WITH A COPY OF THE APPROVED PLANS AND AN ACCURATE AS-BUILT DRAWING OF ANY EXISTING SANITARY FACILITIES.
- 19. THE DESIGN ENGINEER WILL BE REQUIRED TO CERTIFY THE COMPLETED DISPOSAL FACILITY WITH AN AS-BUILT DRAWING SUBMITTED TO THE TOWN PRIOR TO CERTIFICATE OF OCCUPANCY BEING ISSUED.
- 20. THERE SHALL BE NO REGRADING, EXCEPT AS SHOWN ON THE APPROVED PLANS, IN THE AREA OF ABSORPTION FIELDS.
- 21. SEPTIC TANKS SHALL BE INSPECTED PERIODICALLY PUMPED EVERY 2-3 YEARS 22. DISTRIBUTION BOXES/DROP BOXES SHOULD BE INSPECTED PERIODICALLY TO
- ASSURE THAT THEY ARE LEVEL AND OPERATING PROPERLY. 23. A NYS LICENSED PROFESSIONAL ENGINEER SHALL INSPECT THE SANITARY FACILITIES AT THE TIME OF CONSTRUCTION. THE ENGINEER SHALL CERTIFY TO THE ORANGE COUNTY DEPARTMENT OF HEALTH AND THE LOCAL CODE ENFORCEMENT OFFICER THAT THE FACILITIES HAVE BEEN INSTALLED IN ACCORDANCE WITH THE APPROVED PLANS AND THAT ANY SEPTIC TANK JOINTS HAVE BEEN SEALED AND TESTED FOR WATER TIGHTNESS.

STANDARD NOTES:

THE DESIGN, CONSTRUCTION AND INSTALLATION SHALL BE IN ACCORDANCE WITH THIS PLAN AND GENERALLY ACCEPTED STANDARDS IN EFFECT AT THE TIME OF CONSTRUCTION WHICH INCLUDE:

"RURAL WATER SUPPLY. NEW YORK STATE DEPARTMENT OF HEALTH." "PLANNING THE SUBDIVISION AS PART OF THE TOTAL ENVIRONMENT. NEW YORK STATE DEPARTMENT OF HEALTH."

"DESIGN STANDARDS FOR WASTE TREATMENT WATER WORKS- 1988" "NEW YORK STATE DEPARTMENT OF HEALTH AND ORANGE COUNTY DEPARTMENT OF HEALTH POLICIES, PROCEDURES AND STANDARDS.

"THIS PLAN IS APPROVED AS MEETING THE APPROPRIATE AND APPLIED TECHNICAL STANDARDS, GUIDELINES, POLICIES AND PROCEDURES FOR ARRANGEMENT OF SEWAGE DISPOSAL AND TREATMENT AND WATER SUPPLY FACILITIES.

ALL WELLS AND S.D.S. EXISTING OR APPROVED WITHIN 200' OF THE PROPOSED WELLS AND S.D.S. ARE SHOWN ON THIS PLAN ALONG WITH ANY OTHER ENVIRONMENTAL HAZARDS IN THE AREA THAT MAY AFFECT THE DESIGN AND FUNCTIONAL ABILITY OF THE S.D.S. AND WELL. IT SHALL BE DEMONSTRATED BY THE CONTRACTOR TO THE CERTIFYING ENGINEER THAT THE SEPTIC TANK IS SEALED, WATER TIGHT AND ACCEPTABLE FOR USE. THIS SHALL REQUIRE, AS A MINIMUM, THE FILLING OF THE TANK WITH WATER TO OBSERVE IF IT IS IN FACT SEALED. WATERTIGHT AND ACCEPTABLE FOR USE. ALL PROPOSED WELLS AND SERVICE LINES ON THIS PLAN ARE ACCESSIBLE FOR


INSTALLATION AND PLACEMENT. TRENCH BOTTOMS TO BE SET LEVEL AND PARALLEL TO EXISTING CONTOURS.

COUNTY CERTIFICATION:

"THE PROPOSED SEWAGE DISPOSAL SYSTEM AND WATER SUPPLY SYSTEM SHOWN ARE DESIGNED IN ACCORDANCE WITH THE STANDARDS AND REQUIREMENTS ESTABLISHED BY THE NEW YORK STATE DEPARTMENT OF HEALTH AND THE NEW YORK STATE DEPARTMENT OF ENVIRONMENTAL CONSERVATION. THE DESIGN IS BASED UPON THE ACTUAL SOIL AND SITE CONDITIONS FOUND UPON THE LOT AT THE DESIGN LOCATION AT THE TIME OF DESIGN."

TOWN CERTIFICATION:


"I HEREBY CERTIFY TO THE TOWN OF NEWBURGH THAT THE SEWAGE DISPOSAL SYSTEM DEPICTED ON THIS PLAT HAS BEEN DESIGNED IN ACCORDANCE WITH THE NEW YORK STATE PUBLIC HEALTH LAW AND ALL REGULATIONS PROMULGATED THEREUNDER."

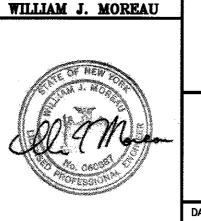


ENGINEER

PROPOSED SITE PLAN NEWBURGH PARK ASSOCIATES, INC. SEPTIC DETAILS SBL: 89-1-19.22 TOWN OF NEWBURGH, ORANGE COUNTY, NY


SHEET NUMBER 15-008-PMU 7/7/2016 1"=30' 4 OF 5

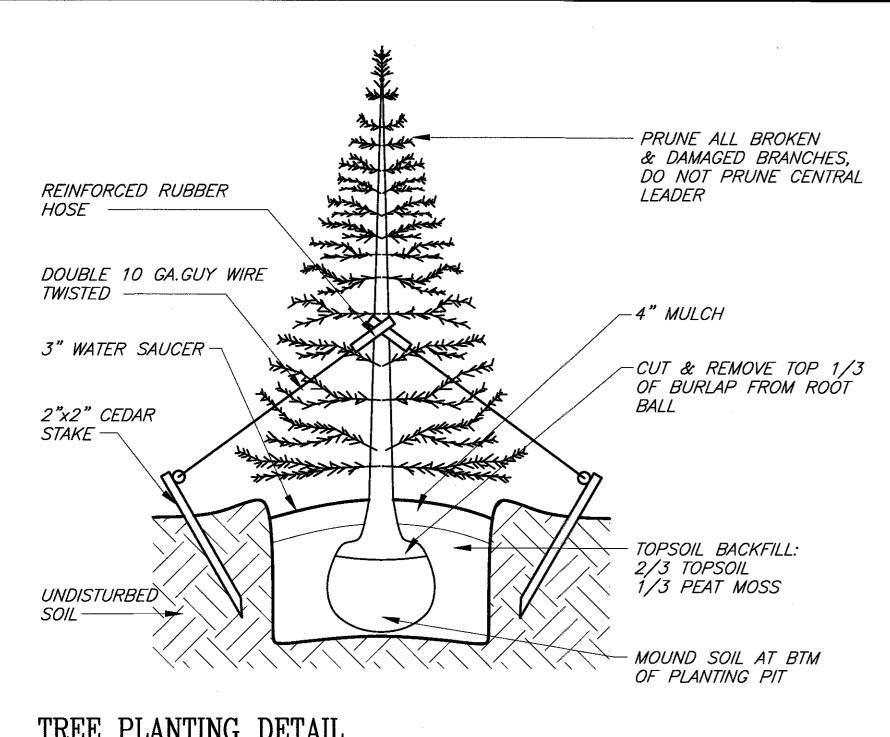

TREE PLANTING DETAIL NO SCALE

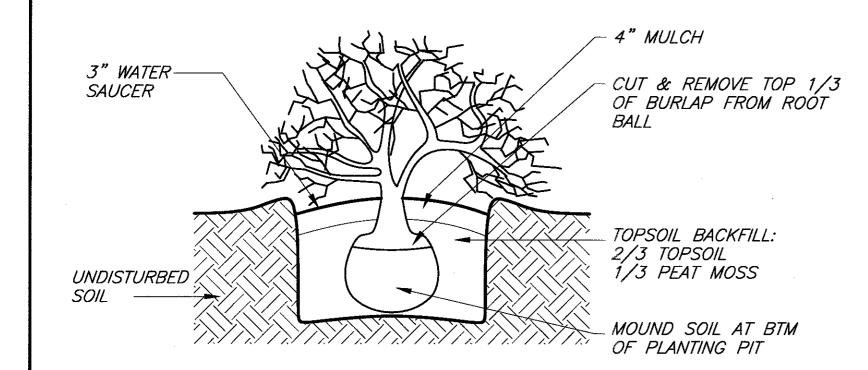


SHRUB PLANTING DETAIL NO SCALE

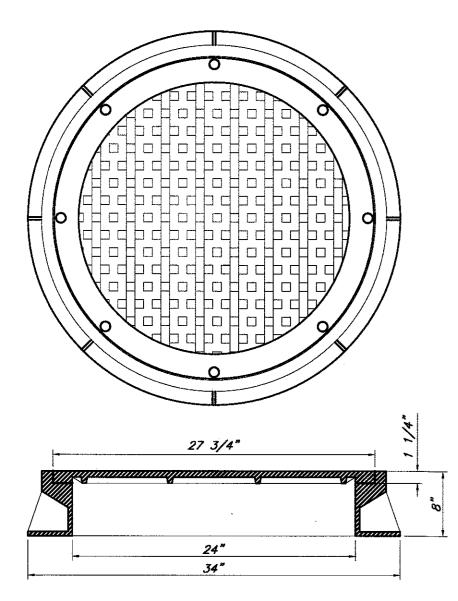

CAMPBELL FOUNDRY CO. HEAVY DUTY BOLTED
WATERTIGHT FRAME & COVER OR EQUAL


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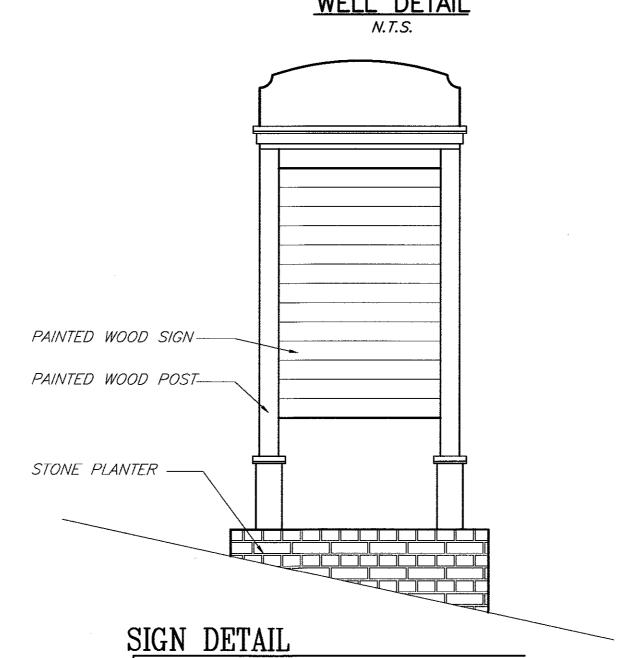
(FOR SEPTIC TANK & PUMP CHAMBER)

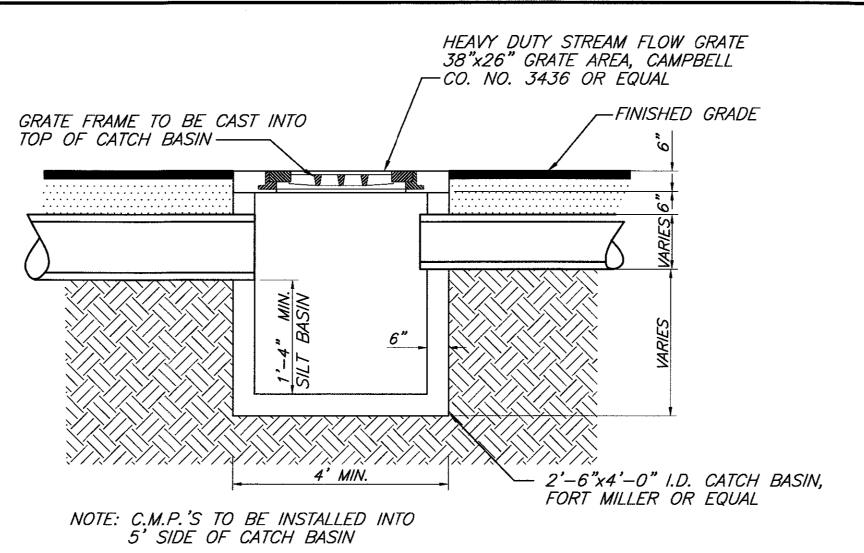


TYPICAL CATCH BASIN DETAIL

NOT TO SCALE




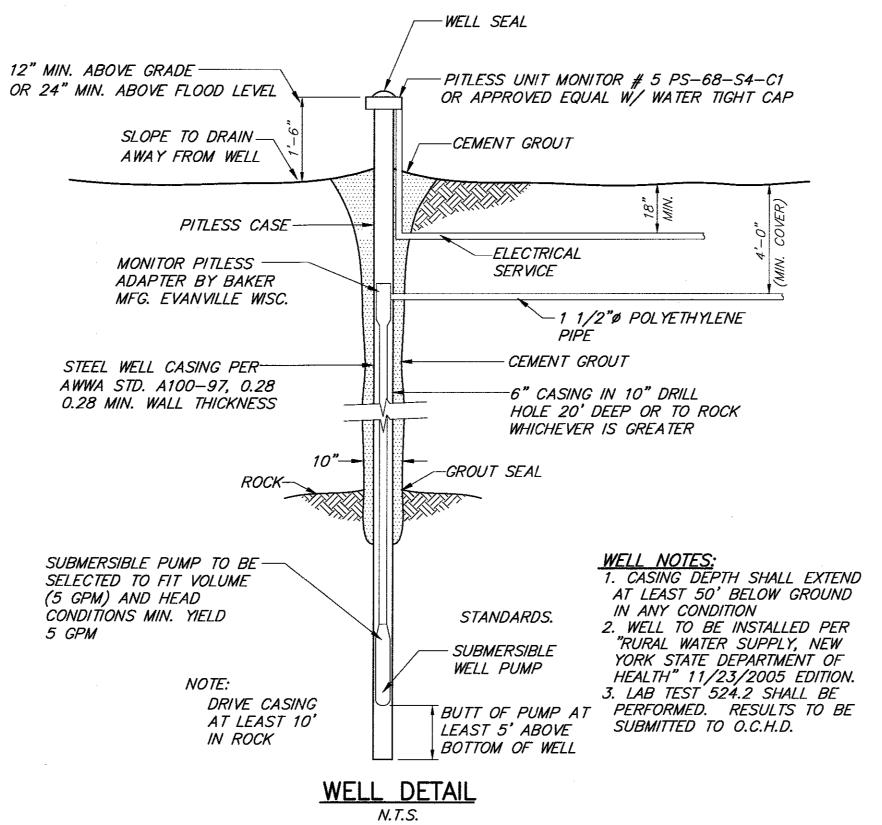

NOT TO SCALE

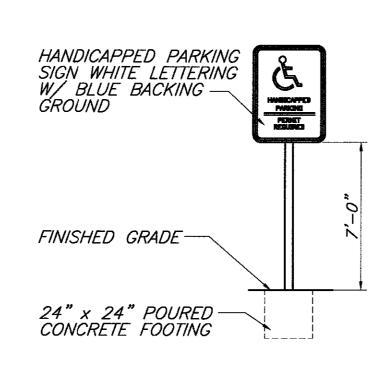


HANDICAP SIGN DETAIL NO SCALE

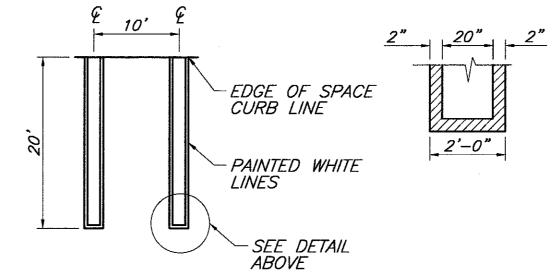


PARKING SPACE DETAIL

NO SCALE

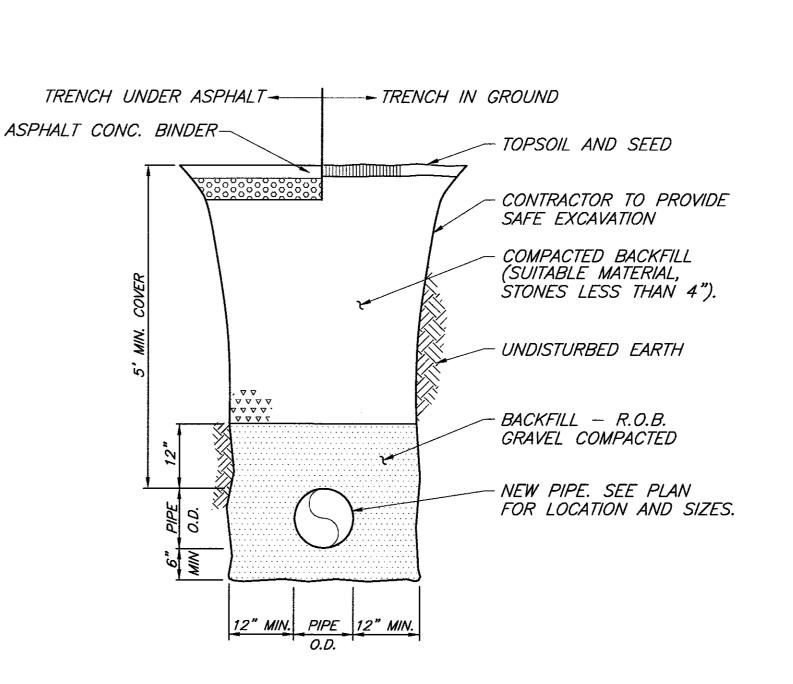



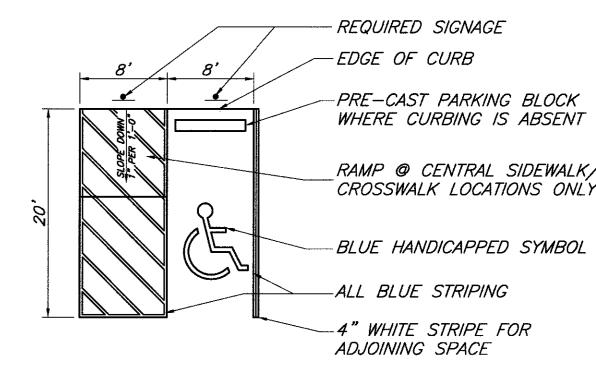


NOTES:

1. SIGN TO BE INSTALLED IN FRONT OF THE CROSS—HATCHED ACCESS LANE OF THE HANDICAPED PARKING SPACE. THE SIGN MUST READ "NO PARKING ANY TIME"

2. ALL STRIPING TO BE BLUE IN COLOR (U.O.N.).

HANDICAP PARKING SPACE DETAIL


NO SCALE

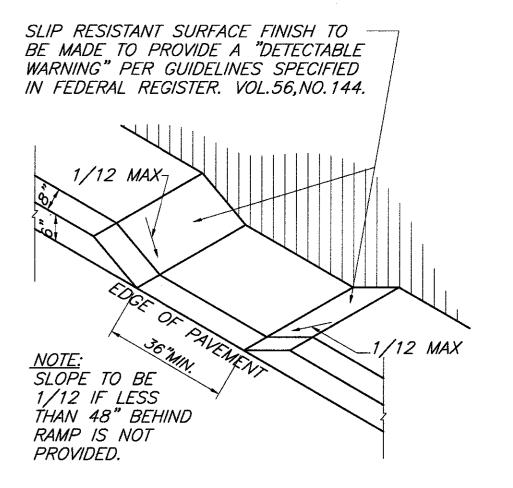

DEPRESSED CURB DETAIL FOR HANDICAP RAMP

NO SCALE

NOT FOR OCHD REVIEW OR APPOVAL

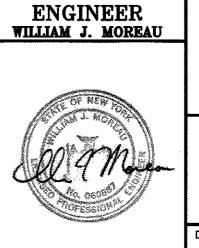

PROPOSED SITE PLAN
NEWBURGH PARK ASSOCIATES, INC.
MISC. DETAILS
SBL: 89-1-19.22

SBL: 89-1-19.22 TOWN OF NEWBURGH, ORANGE COUNTY, NY

DATE SCALE JOB NUMBER SHEET NUMBER 7/7/2016 1"=30" 15-008-PMU 5 0F 5

7. REVISED 10/11/2020 AS PER CLIENT COMMENTS
6. REVISED 10/15/2019 AS PER OCHD COMMENTS
5. REVISED 07/15/2019 AS PER OCHD COMMENTS
4. REVISED 03/25/2018 AS PER ZBA VARIANCE
3. REVISED 12/01/2017 AS PER ZBA COMMENTS
2. REVISED 06/18/2017 AS PER PLANNING BOARD COMMENTS
1. REVISED 09/01/2016 AS PER NYSDOT